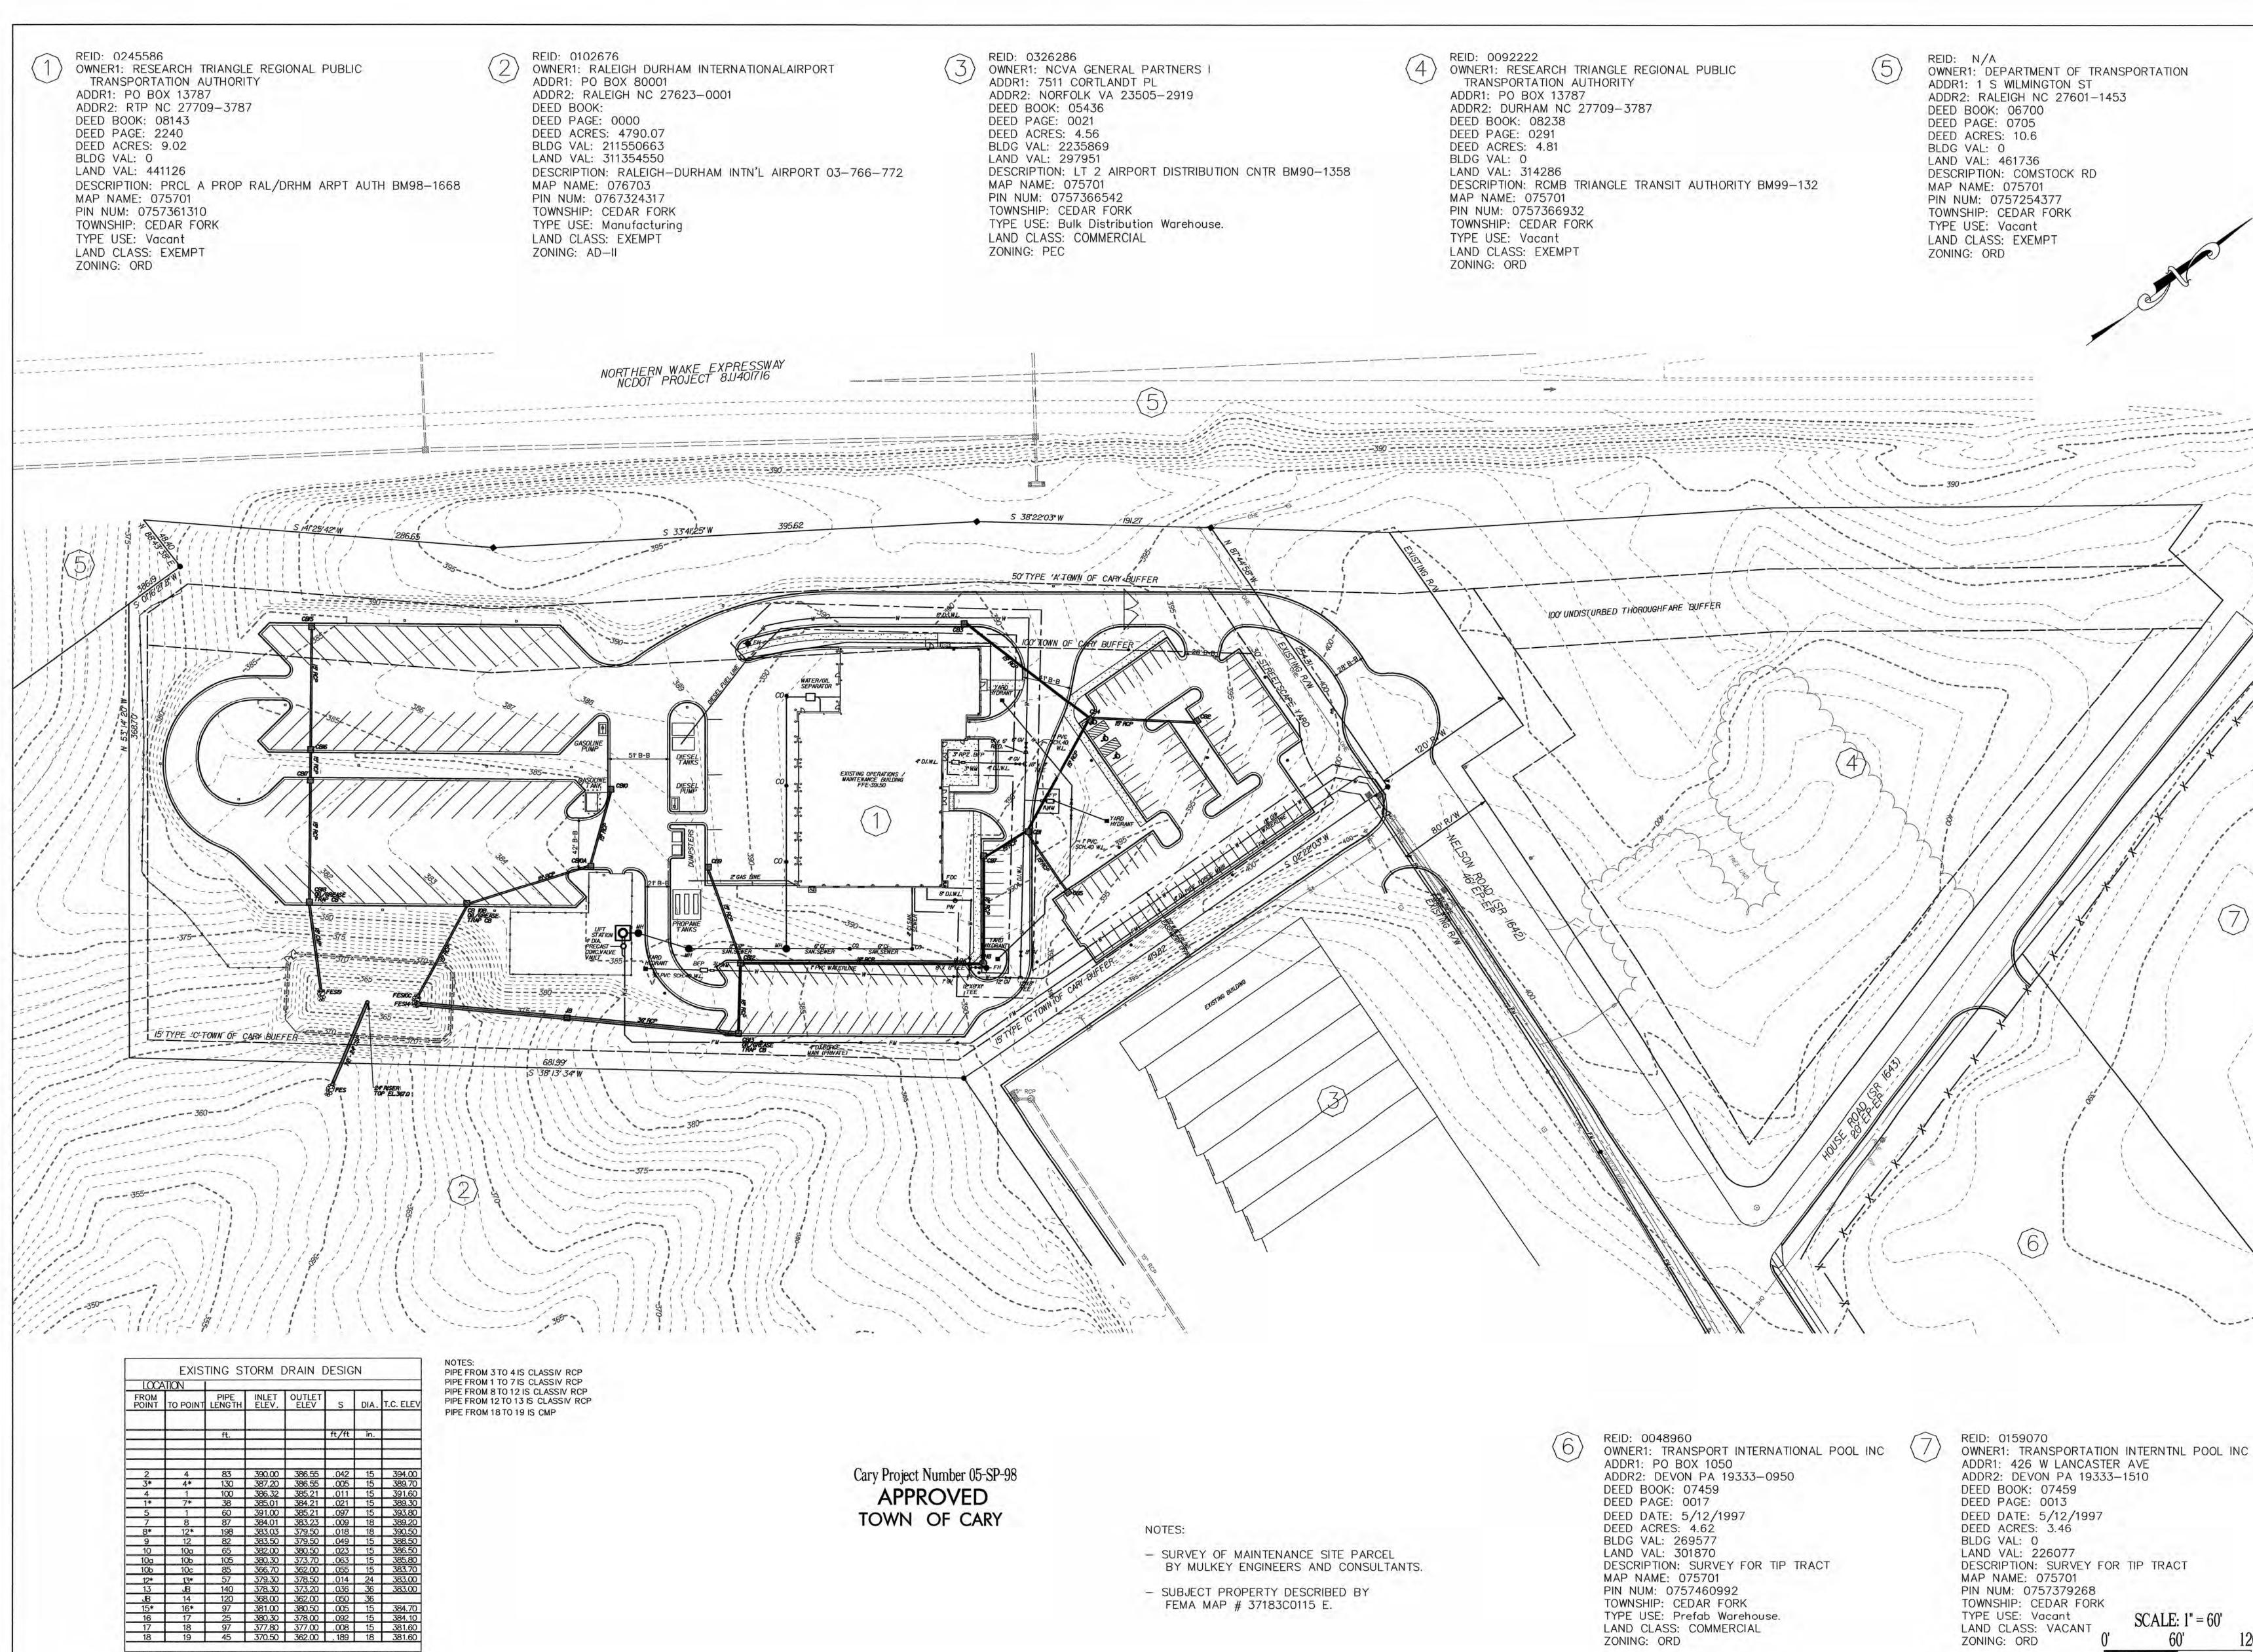
# GoTriangle RFQ 24-048

# **Exhibit C**BOMF Site Additions 2008

(13 pages - including this page)



FEMA MAP # 37183C0115 E.

OWNER1: DEPARTMENT OF TRANSPORTATION ADDR1: 1 S WILMINGTON ST ADDR2: RALEIGH NC 27601-1453 DESCRIPTION: COMSTOCK RD PIN NUM: 0757254377

TOWNSHIP: CEDAR FORK

TYPE USE: Vacant

ZONING: ORD

LAND CLASS: VACANT

PIN NUM: 0757460992

ZONING: ORD

TOWNSHIP: CEDAR FORK

LAND CLASS: COMMERCIAL

TYPE USE: Prefab Warehouse.

NELSON ROAD CARY, NORTH CAROLINA



SOLUTIONS

PHOENIX Greensboro, N. C. 27401
Telephone 336-373-9800

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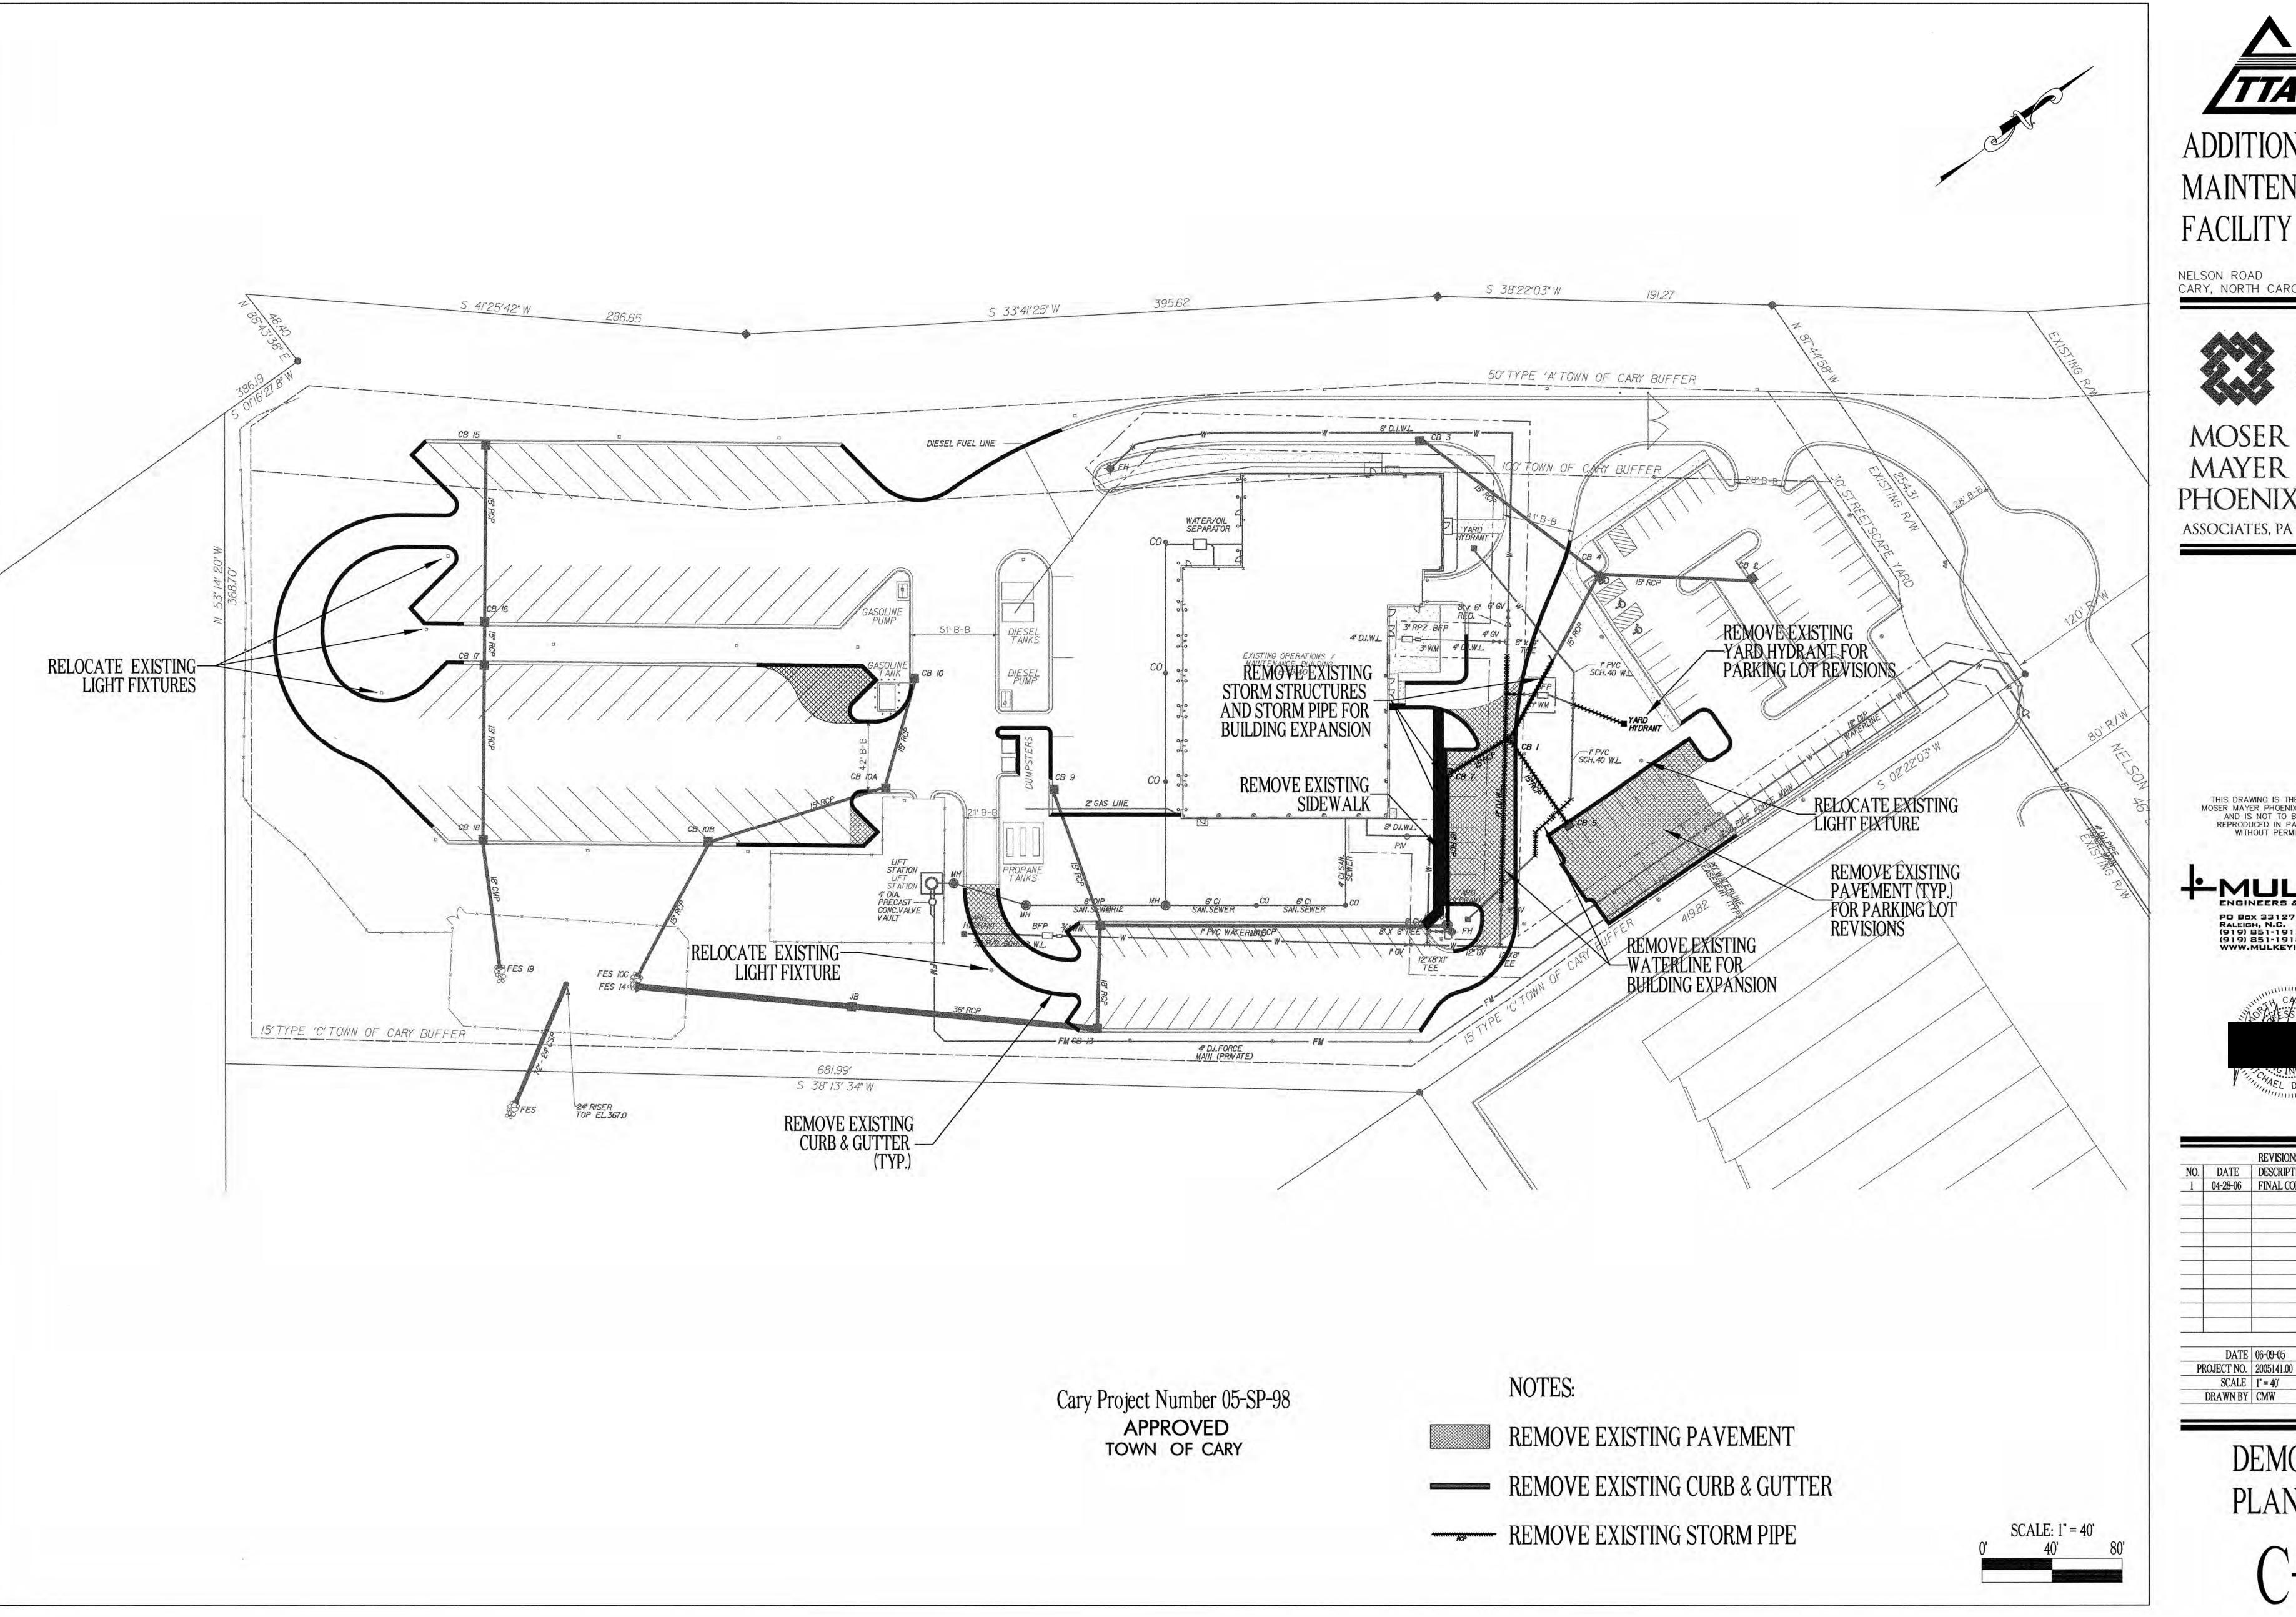
		REVISIONS
NO.	DATE	DESCRIPTION
1	04-28-06	FINAL CONSTRUCTION DRAWINGS
	DATE	06-09-05
PF	OJECT NO.	2005141.00

**EXISTING** 

**CONDITIONS** SCALE: 1'' = 60'

SCALE 1" = 60"

DRAWN BY CMW





NELSON ROAD CARY, NORTH CAROLINA



MOSER

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		The state of the s
	DATE	06-09-05
PF	ROJECT NO.	2005141.00
SCALE		1" = 40'
	DRAWN BY	CMW

**DEMOLITION PLAN** 

GENERAL NOTES:

1. NO CHANGES TO ANY ASPECT OF THIS PLAN, INCLUDING BUT NOT LIMITED TO, LANDSCAPING, GRADING, BUILDING ELEVATIONS (ESPECIALLY COLORS), LIGHTING, OR UTILITIES WILL BE MADE WITHOUT THE APPROVAL OF THE DEVELOPMENT REVIEW GROUP OF THE DEPARTMENT OF PLANNING AND DEVELOPMENT.

- 2. THE SITE SHALL BE STABILIZED AND SEEDED PRIOR TO THE ISSUANCE OF A CERTIFICATE OF OCCUPANCY.
- 3. ALL HVAC SYSTEMS WILL BE SCREENED FROM OFF SITE VIEWS.
- 4. ALL DUMPSTER AND CARDBOARD RECYCLING LOCATIONS WILL BE SCREENED FROM OFF SITE VIEWS.

5. WHERE EXISTING VEGETATION FAILS TO FUNCTION ADEQUATELY AS REQUIRED, (I.E. BUFFER TYPE A, B, C, 30' STREETSCAPE BUFFER. THE CARY SITE INSPECTOR RESERVES THE RIGHT TO REQUIRE SUPPLEMENTAL PLANTINGS IN ADDITION TO THOSE SHOWN ON THE PLANTING PLAN BASED ON ACTUAL FIELD CONDITIONS.

6. ALL EXTERIOR SITE LIGHTING WILL BE DESIGNED TO PREVENT OFF SITE GLARE. 7. THE SIZE OF THE PLANTING AREA AND SIZE OF PLANT MATERIAL AT MATURITY SHALL ALLOW FOR A 2.5' BUMPER OVERHANG FROM THE BACK OF CURB.

8. NO TREE SHALL BE LOCATED WITHIN A ROADWAY RIGHT-OF-WAY OR WITHIN 5'OF A SIDEWALK.

9. NO TREE SHALL BE LOCATED WITHIN 10' OF A LIGHTING LOCATION. 10. ALL TREE PROTECTION FENCING SHALL BE MAINTAINED UNTIL ALL SITE WORK IS COMPLETED. THE FENCING SHALL BE REMOVED PRIOR TO THE FINAL SITE INSPECTION FOR THE CERITFICATE OF OCCUPANCY (CO).

11. ALL ABOVE GROUND UTILITY EQUIPMENT AND FACILITIES ASSOCIATED WITH ON SITE ELECTRIC, CABLE, TELEPHONE, GAS OR OTHER SIMILAR UTILITY SHALL BE IN THE SIDE OR REAR YARD & SHALL BE SCREENED, TO THE EXTENT POSSIBLE, WITH EVERGREEN PLANTINGS. PLANTINGS SHALL ALLOW FOR A MINIMUM OF A 5'CLEARANCE AROUND THE STRUCTURE TO ALLOW FOR ACCESS. ADDITIONALLY, ANY SIDE OF THE STRUCTURE HAVING A DOOR OR LOCK, THE PLANTINGS SHALL ALLOW FOR A 10'CLEARANCE. THE AMOUNT OF CLEARANCE SHALL ACCOUNT FOR THE SIZE OF THE PLANT MATERIAL AT MATURITY.

12. ALL VEHICULAR USE AREAS (DRIVES AND PARKING AREAS) SHALL BE SCREENED FROM OFFSITE VIEWS.

13. ALL SITE CONSTRUCTION MUST BE PERFORMED IN ACCORDANCE WITH CURRENT TOWN OF CARY STANDARD SPECIFICATIONS AND DETAILS AND ALL ROADWAY CONSTRUCTION WITH CURRENT NCDOT STANDARDS AND SPECIFICATIONS.

14. ALL WORK MUST COMPLY WITH NC STATE BUILDING AND HANDICAPPED ACCESSIBILITY CODE VOL 1C.

15. ANY RETAINING WALLS ON THE SITE OVER 5' HIGH REQUIRE A BUILDING PERMIT.

16. ALL CONSTRUCTION MUST BE PERFORMED IN ACCORDANCE WITH CURRENT TOWN OF CARY STANDARD SPECIFICATIONS AND DETAILS.

17. ALL ADJACENT STREETS IN THE VICINITY OF THIS PROJECT SHALL BE KEPT CLEAN AT ALL TIMES WITH RESPECT TO CONSTRUCTION TRAFFIC. IF THEY ARE NOT, A WASH STATION WILL BE REQUIRED.

18. THE TREE PROTECTION FENCING SHALL BE INSTALLED AND INSPECTED PRIOR TO THE ISSUANCE OF A GRADING PERMIT FOR THIS PROJECT.

19. THIS PROJECT DRAINS TO AN UNNAMED TRIBUTARY OF STIRRUP IRON CREEK.

20. APPROVED, STAMPED AND SIGNED BUILDING ELEVATIONS FROM THIS SITE PLAN MUST BE INCORPORATED IN THE BUILDING PERMIT PLANS. 21. THE DEVELOPER WILL BE RESPONSIBLE FOR ALL INSTALLATION COSTS ASSOCIATED WITH STREET LIGHTING ALONG PROPOSED STREETS, ADJACENT STREETS AND THOROUGHFARES AS REQUIRED PER TOWN OF CARY POLICY STATEMENT NO. 13. THE DEVELOPER SHALL CONTACT PROGRESS ENERGY AFTER PLAN APPROVAL AND PRIOR TO CONSTRUCTION IN ORDER TO DEVELOP A STREET LIGHTING PLAN FOR THE SITE-SUBDIVISION PLANS.

22. PROPOSED DENUDED AREA = 3.18 AC.

33 HATCHING DENOTES

**NEW PAVEMENT** 

23. BIKE RACKS WILL BE INCORPORATED INTO THE SITE IN CONFORMANCE WITH THE ASSOCIATION OF PEDESTRIAN AND BICYCLE PROFESSIONALS BICYCLE PARKING GUIDELINES ADOPTED SPRING

PROPOSED PUBLIC UTILITIES

S 38°22'03" W

8" WATERLINE

**%IMPERVIOUS** 0.00% PARKING (MAIN COMPLEX) **EXISTING TO REMAIN:** PROPOSED SPACES: TOTAL: HANDICAP SPACES:

> **BUS PARKING: VAN PARKING:**

TOTAL BUSVAN:

5210 NELSON ROAD (VACANT LOT) PRE-DEVELOPMENT:

SITE DATA

TOTAL ACRES

%IMPERVIOUS

TOTAL ACRES

BUS/VAN:

PERVIOUS ACRES

PERVIOUS ACRES

CARY PROJECT # 05-SP-098

ZONING....ORD (BOTH PARCELS)

5201 NELSON ROAD (MAINT. SITE) PRE-DEVELOPMENT:

IMPERVIOUS ACRES 4.30 AC

IMPERVIOUS ACRES 0.00 AC

PROPERTY OWNER....RESEARCH TRIANGLE REGIONAL PUBLIC TRANSPORTATION AUTHORITY

PIN #....0245586 (MAINTENANCE SITE), 0092222 (VACANT LOT)

9.02 AC

4.72 AC

47.7%

4.81 AC

4.81 AC

PROPERTY ADDRESS....5201 NELSON ROAD (MAINT, SITE), 5210 NELSON ROAD (VACANT LOT)

PHASE 1B PROPOSED SPACES: 47 **FUTURE SPACES:** TOTAL:

EMPLOYEE:

PARKING (OVERFLOW LOT)

POST-DEVELOPMENT:

IMPERVIOUS ACRES

POST-DEVELOPMENT:

IMPERVIOUS ACRES

PERVIOUS ACRES

PERVIOUS ACRES

TOTAL ACRES

%IMPERVIOUS

TOTAL ACRES

%IMPERVIOUS

PHASE 1B PROPOSED SPACES: FUTURE SPACES: TOTAL:

9.02 AC

5.09 AC

3.93 AC

4.81 AC

1.78 AC

3.03 AC

36.9%

56.4%

# NOTES

These notes set forth here shall apply to each and every sheet.

All site construction shall be in accordance with Town of Cary standards and specifications details and all road construction shall be per NCDOT Standards and Specifications details.

The Engineer does not guarantee that all existing facilities such as pipelines, electrical lines, conduit, telephone cable, service connections, or other facilities are shown on the plans. It shall be the Contractor's responsibility to have all utilities located by their respective owners, field mark the utility locations, and protect all such existing facilities prior to beginning construction. The Contractor is fully responsible for notifying all utility owners in accordance with NC General Statute - Chapter 87, Article 8, The Underground Damage Prevention Act.

**EXISTING GROSS FLOOR AREA:** 15,726 SF 2,737 SF PROPOSED GROSS FLOOR AREA: TOTAL GROSS FLOOR AREA: 18,463 SF PARKING SPACES REQ. (1/200 SF): 92 SPACES

PARKING REQUIREMENTS

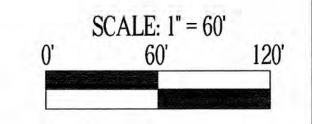
PARKING SPACES PROVIDED: 106 SPACES (EXISTING + PHASE 1B)

(SEE SHEET C-6 FOR PAVEMENT DETAILS) 50 TYPE 'A' TOWN OF CARY BUFFER 100' UNDISTURBED THOROUGHFARE BUFFER CONCRETE SIDEWALK ONE WAY PROPOSED ADJACENT TO CURB. STORM POND 57 EXISTING PARKING SPACES TO REMAIN CORB & 51'8-8 EXPANDED BUS PARKING AREA EXISTING OPERATIONS / MAINTENANCE BUILDING FFE-39150 DIESEL NEW PAVEMENT SEE FLOOR PLAN SHEET FOR DETAILS & GUTTER (TO REMAIN (TYP.) PROPOSED ADDITION SEE FLOOR PLAN SHEET FOR DETAILS. EXISTING PAVEMENT PROPOSED 24" CURB **EXISTING STORM** TO REMAIN (TYP.) & GUTTER IN BOLD **CURB & GUTTER** POND TO REMAIN TO REMAIN (TYP.) 15' TYPE 'C' TOWN OF CARY BUFFER PROPOSED 5 CONCRETE SIDEWAD S 38° 13' 34° W 1' INSIDE'R/W **CURB & GUTTER** TO REMAIN (TYP.)

Cary Project Number 05-SP-98

APPROVED

TOWN OF CARY





NELSON ROAD CARY, NORTH CAROLINA



COMPLETE FACILITIES SOLUTIONS

MOSER 328 E. Market Street Suite 200 PHOENIX Greensboro, N. C. 27401
Telephone 336-373-9800 Fax 336-373-0077 ASSOCIATES, PA

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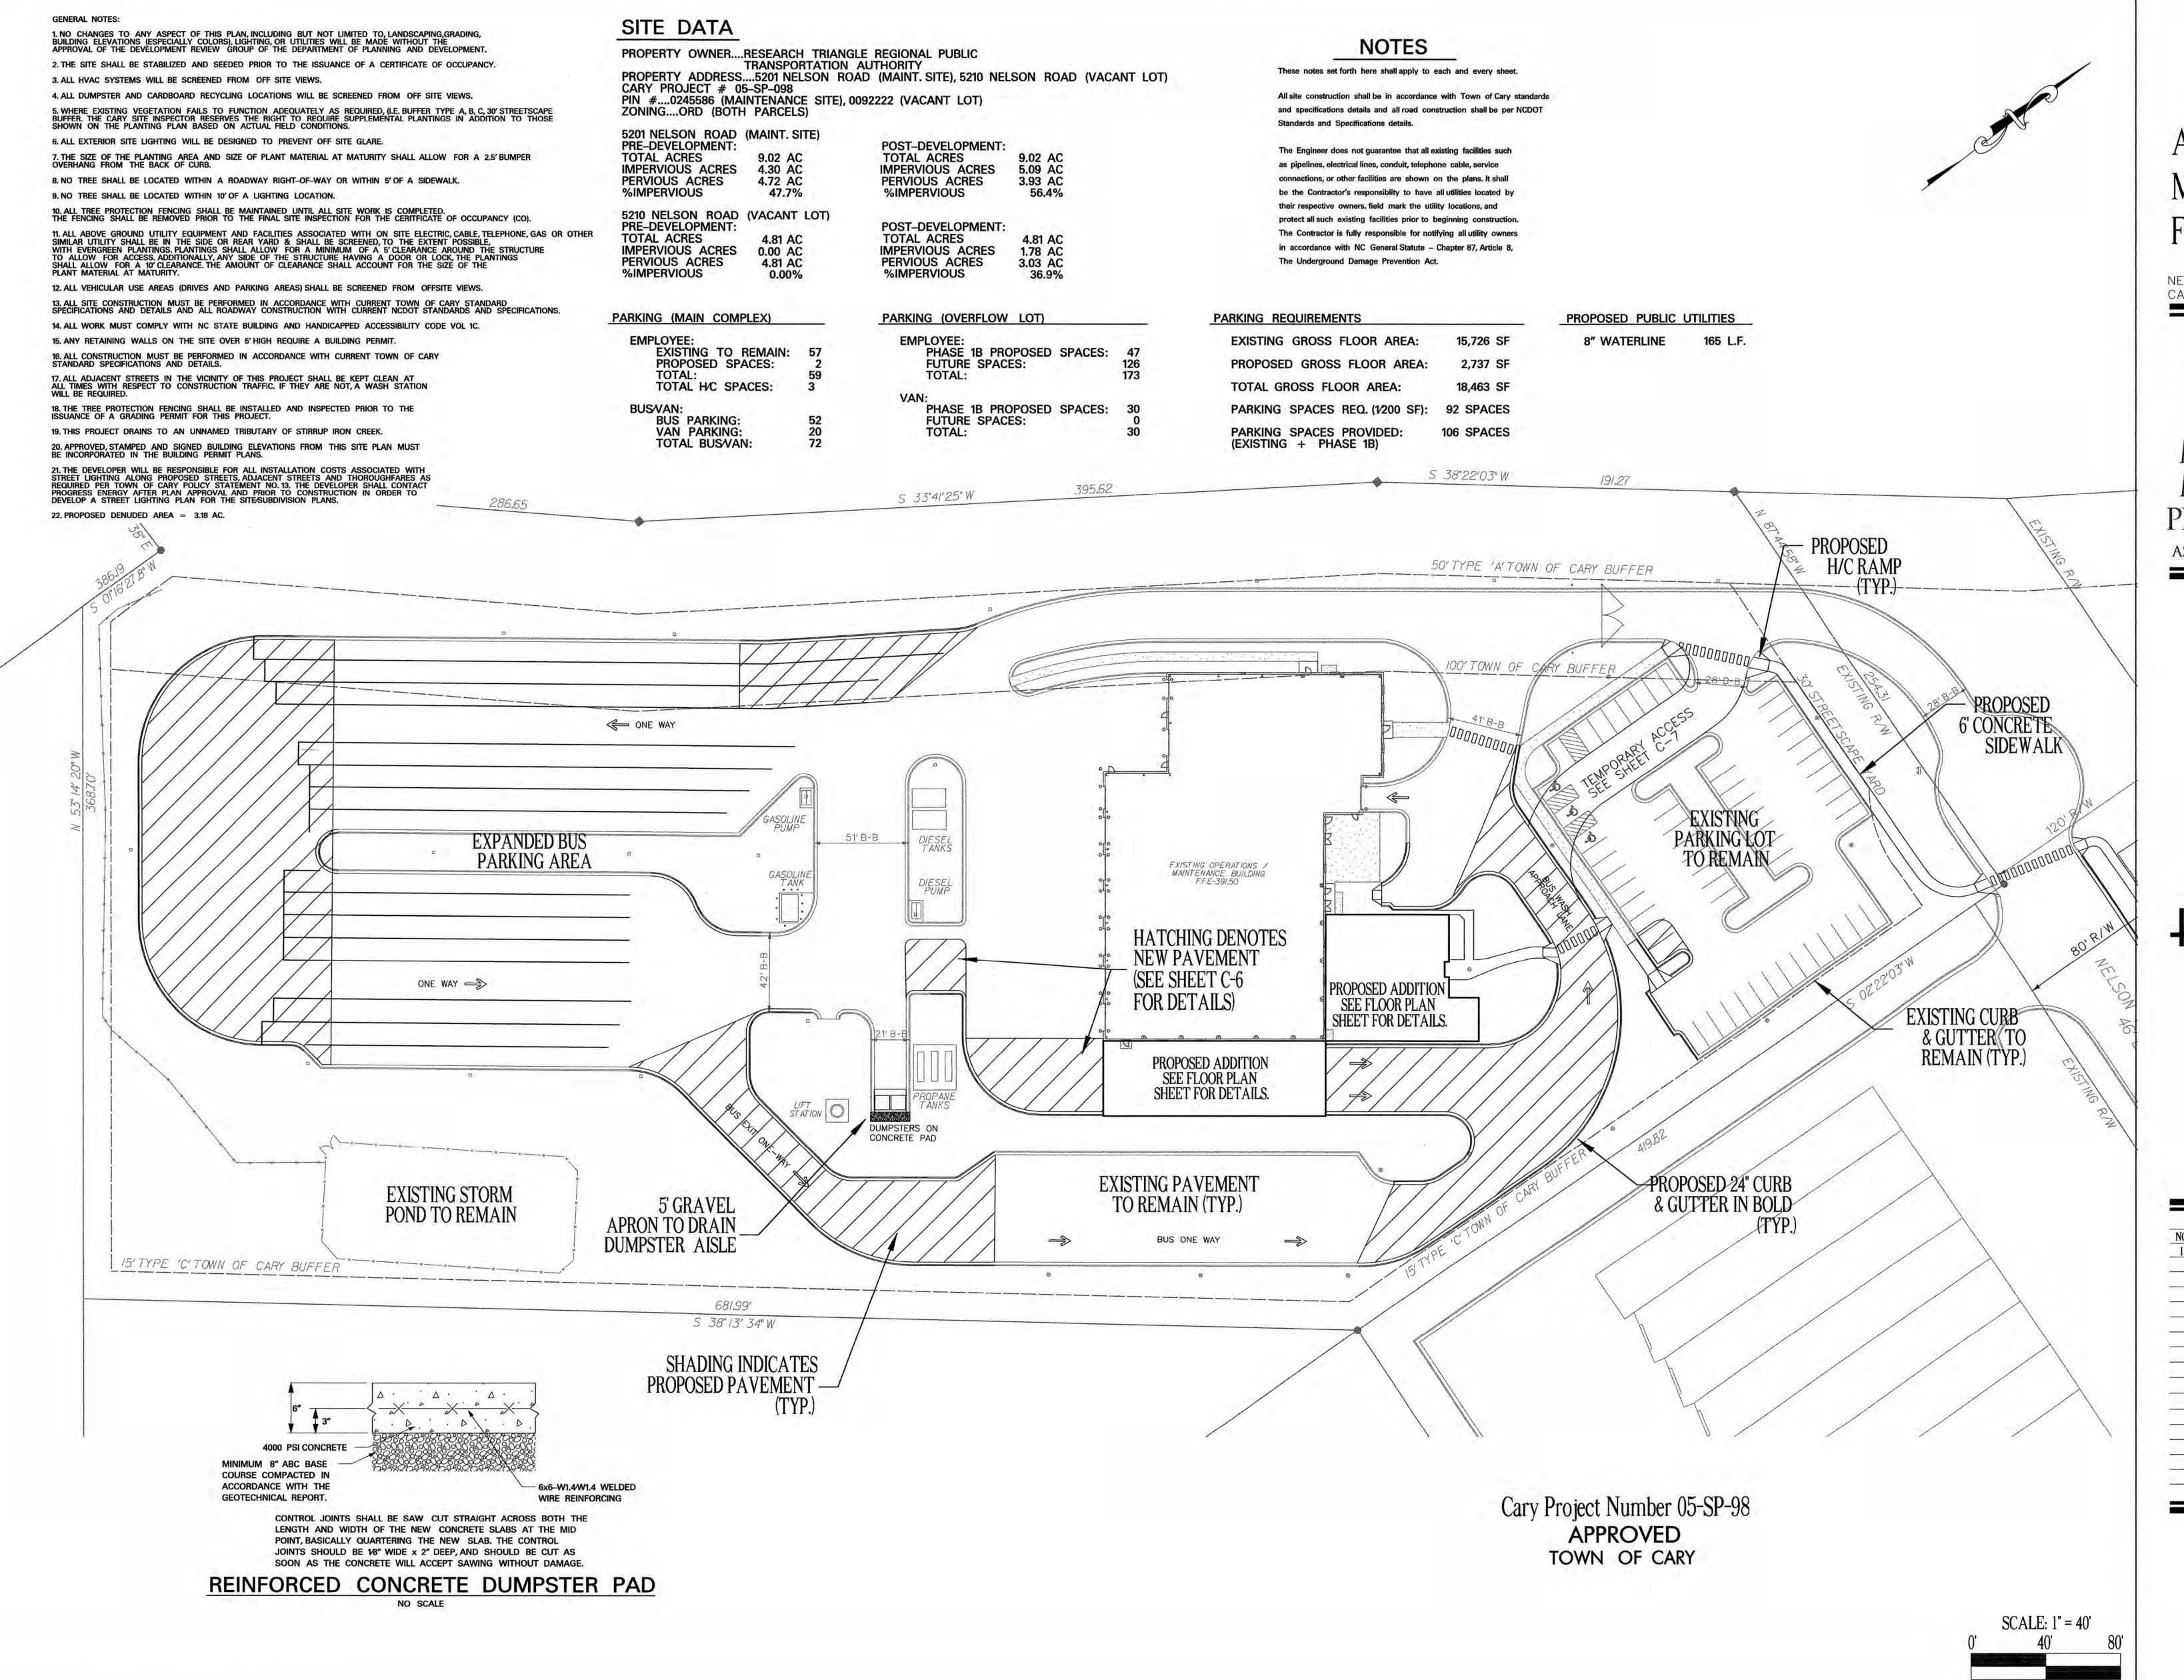




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	CCALE	1" - 60'

SITE PLAN OVERALL

DRAWN BY | CMW



ADDITIONS TO MAINTENANCE FACILITY

NELSON ROAD CARY, NORTH CAROLINA



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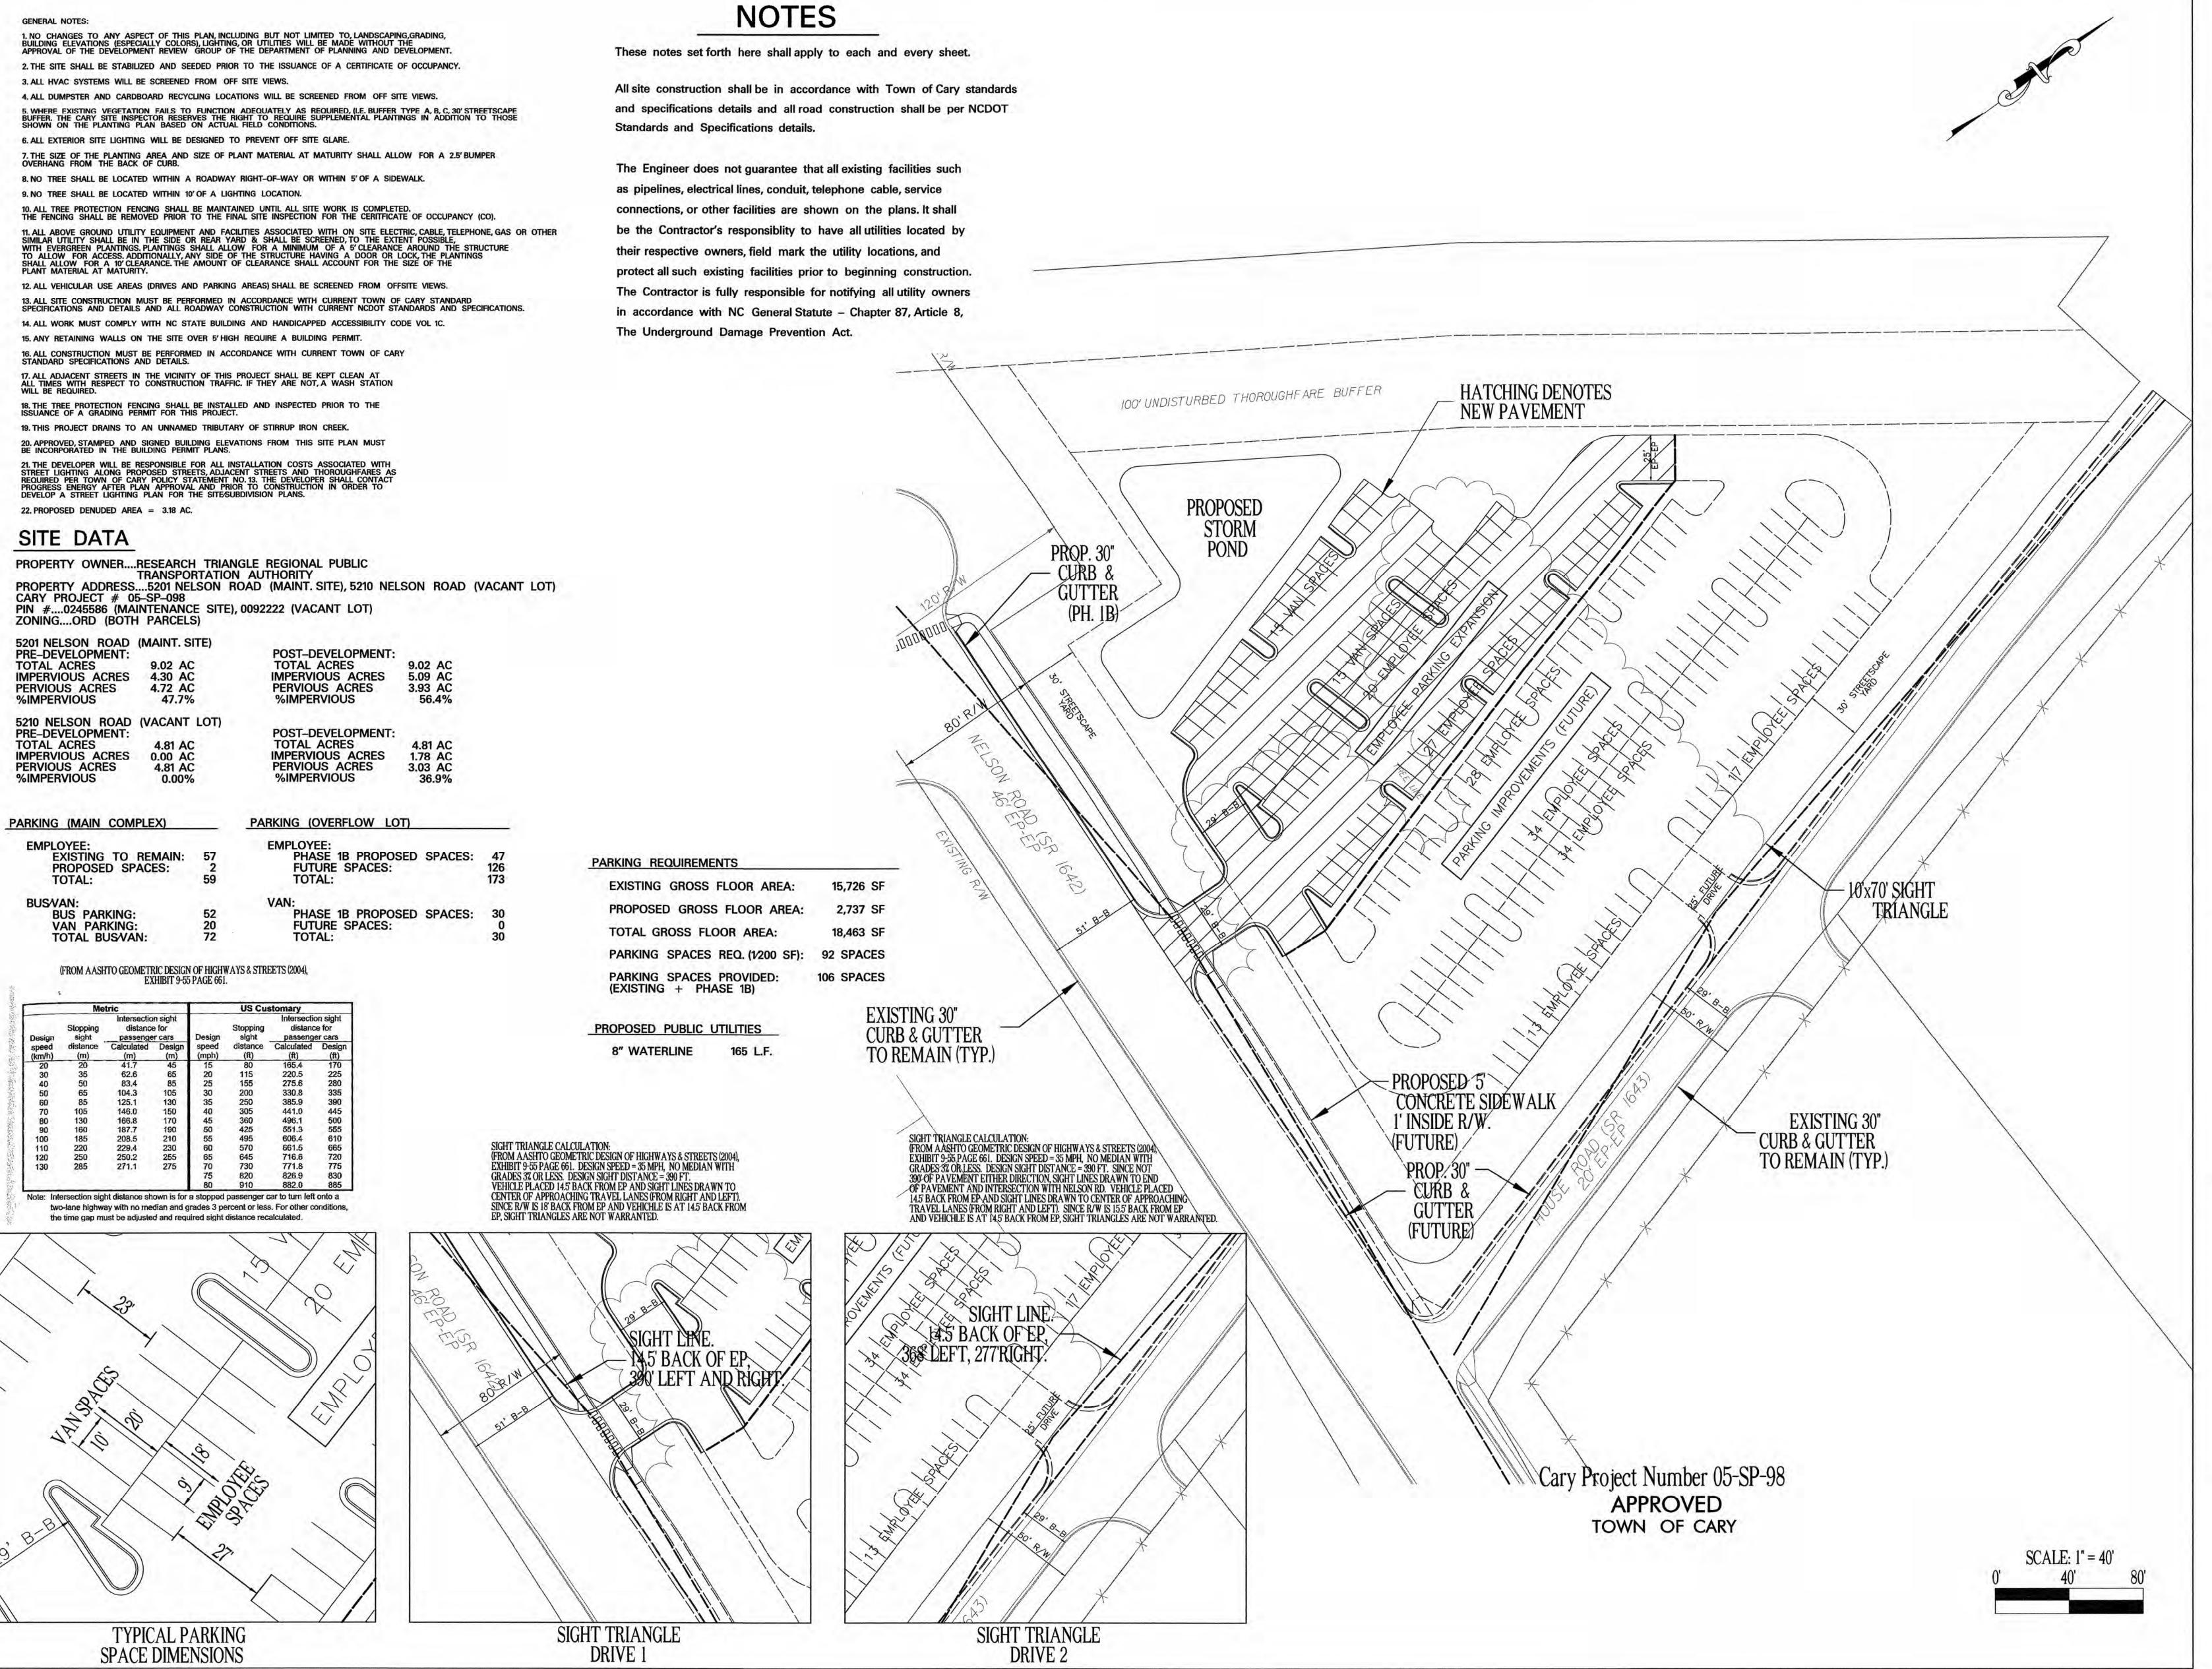




		REVISIONS
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1	04-28-06	FINAL CONSTRUCTION DRAWINGS
	DATE	06-09-05
PROJECT NO.		2005141.00
SCALE		1" = 40'
	DRAWN BY	CMW

SITE PLAN MAINT. SITE

**-3a** 





NELSON ROAD CARY, NORTH CAROLINA



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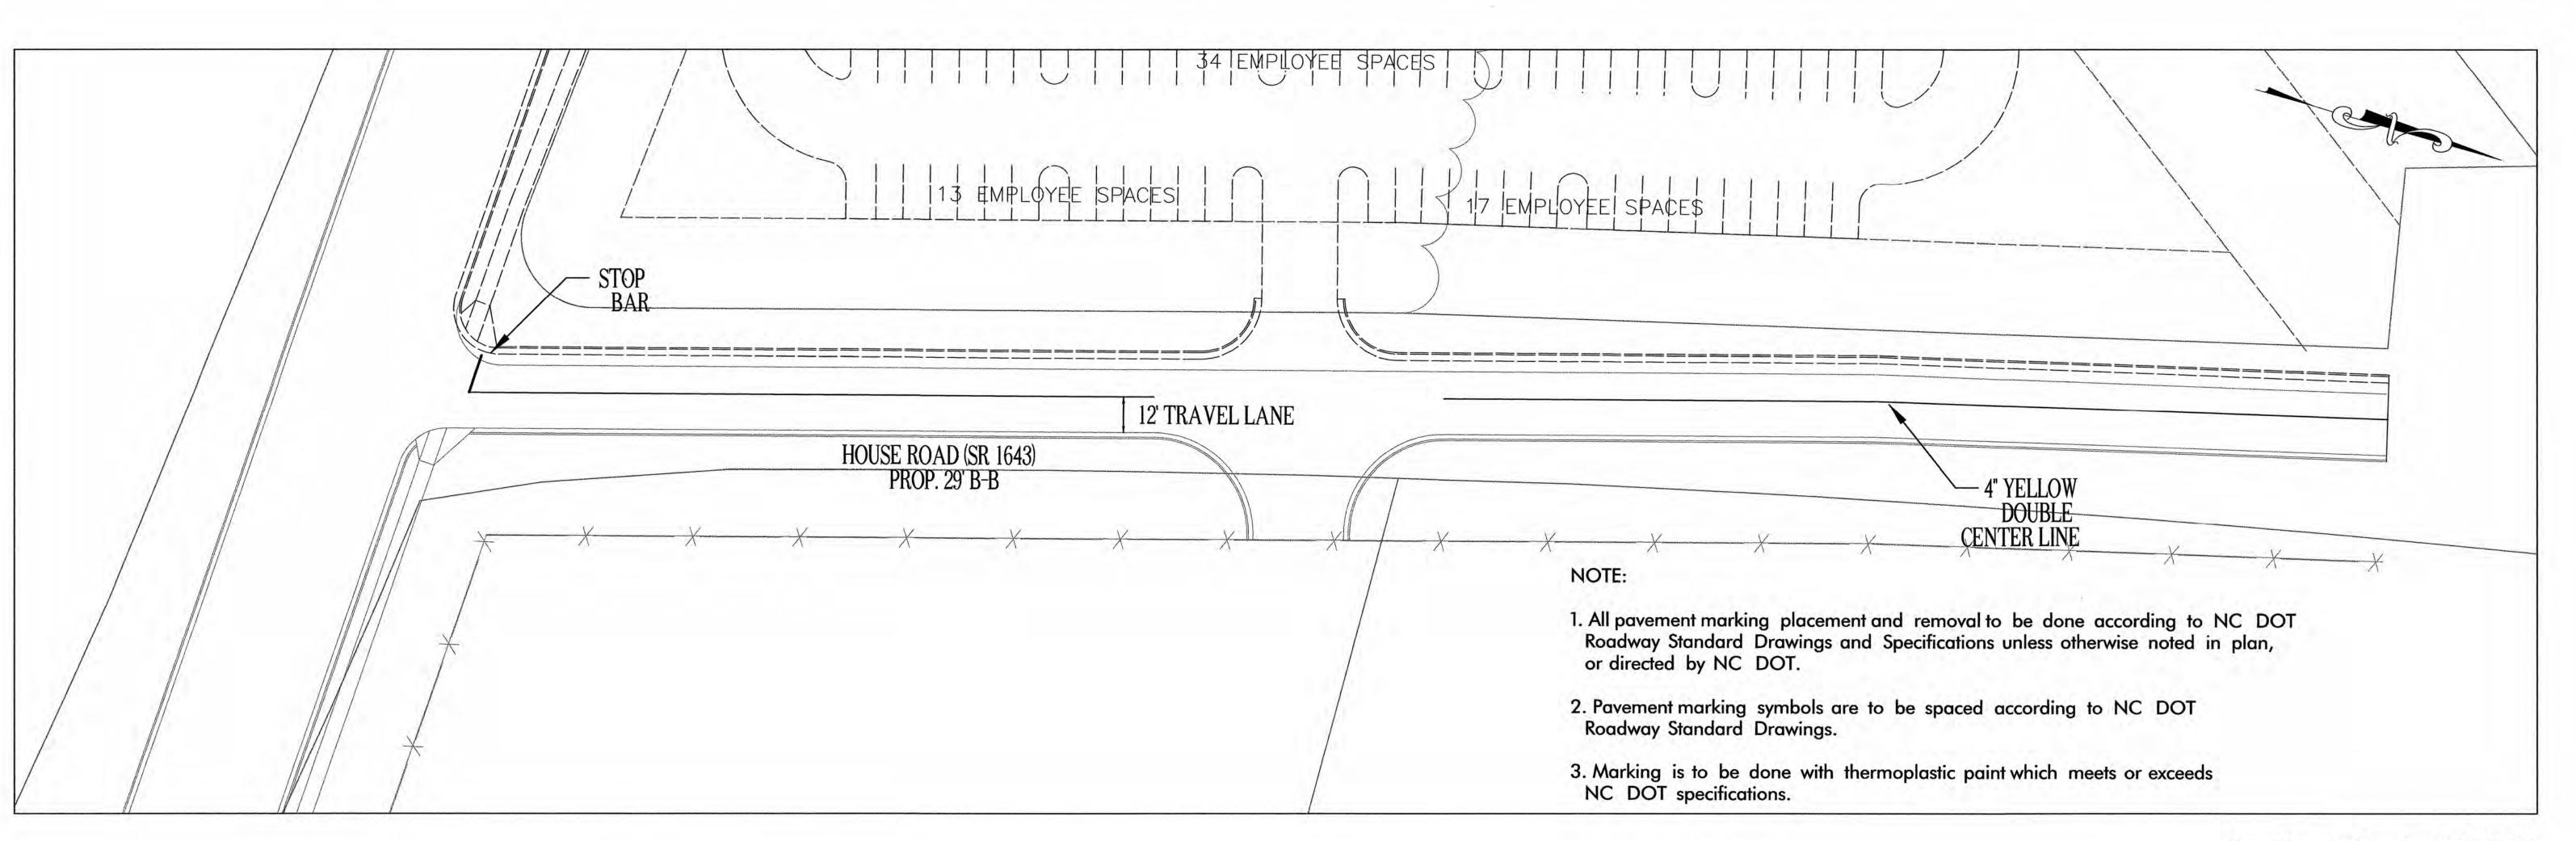
		REVISIONS
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PR	OJECT NO.	2005141.00

SCALE | 1" = 40'
DRAWN BY | CMW

SITE PLAN VACANT LOT

C-3b

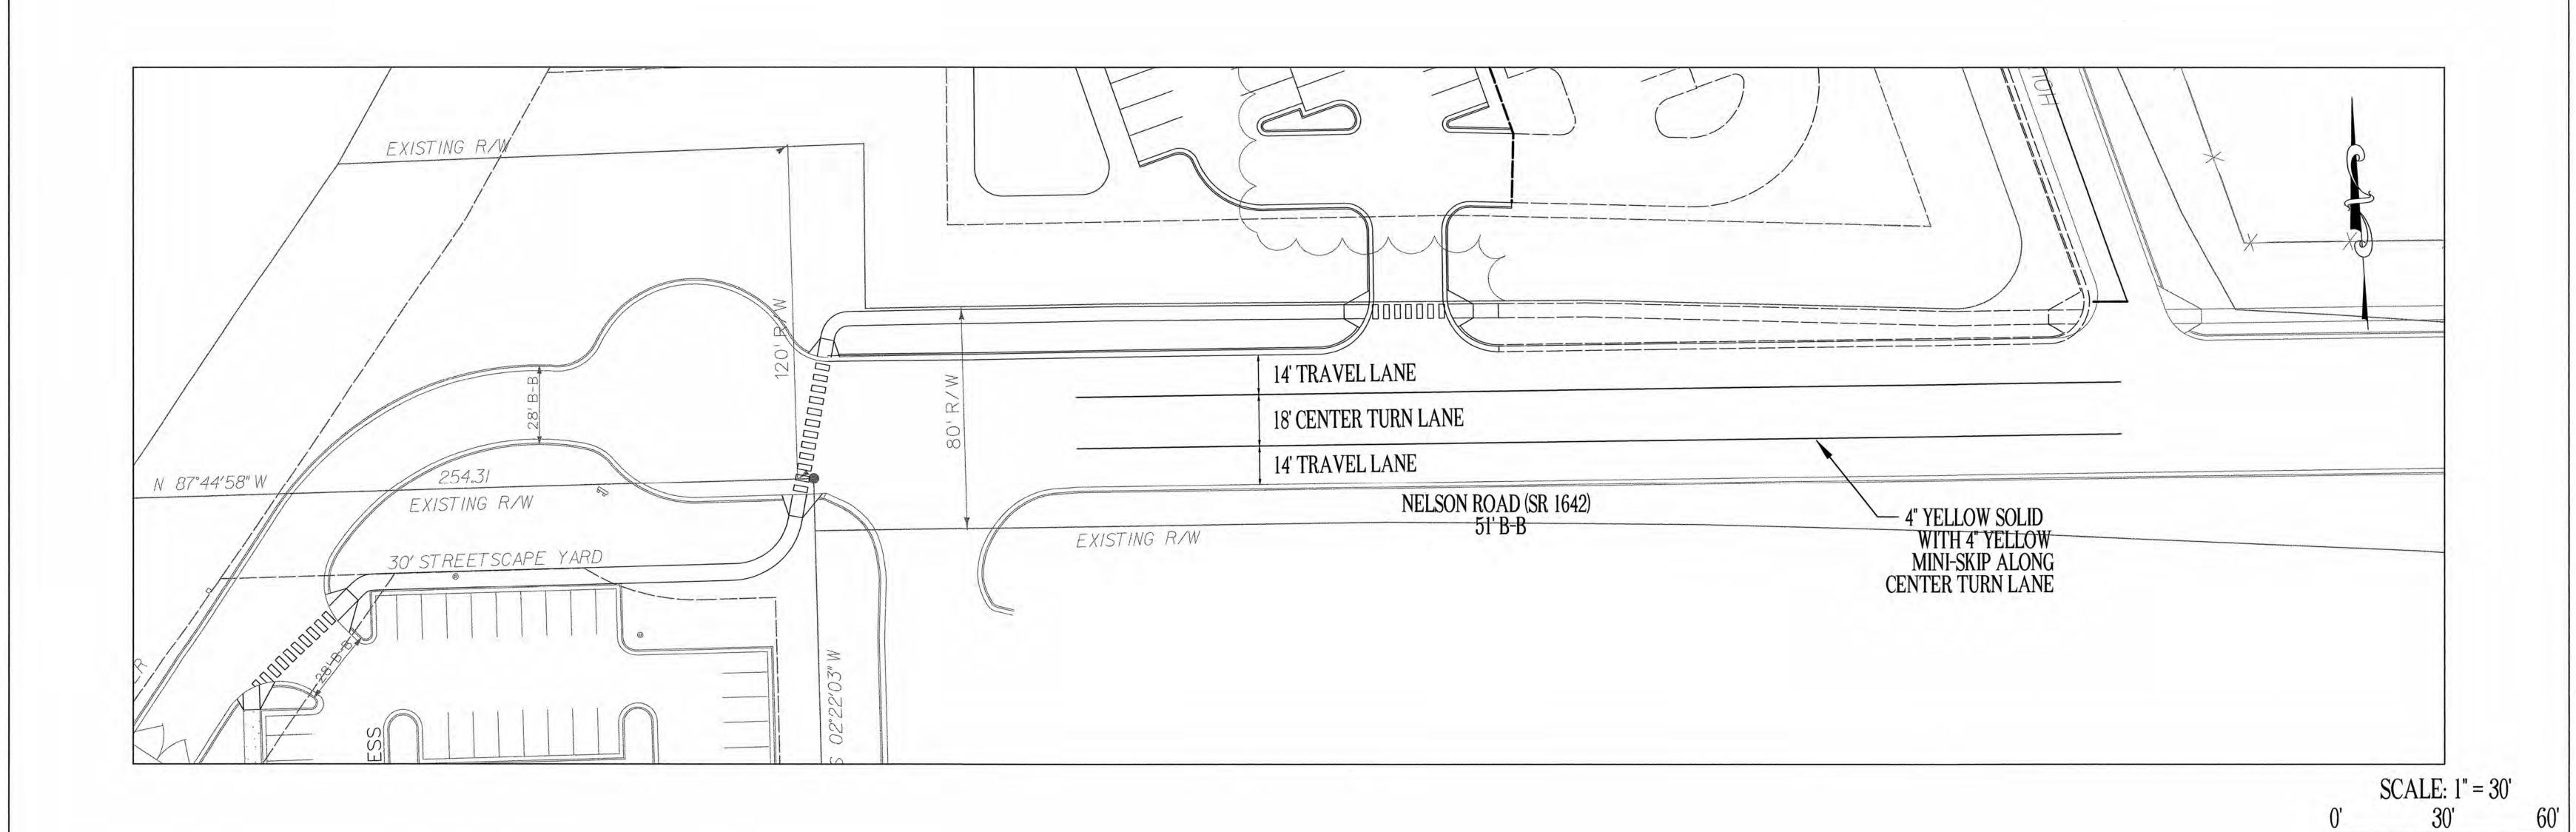
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Cary Project Number 05-SP-98

APPROVED

TOWN OF CARY



ADDITIONS TO MAINTENANCE FACILITY

NELSON ROAD CARY, NORTH CAROLINA



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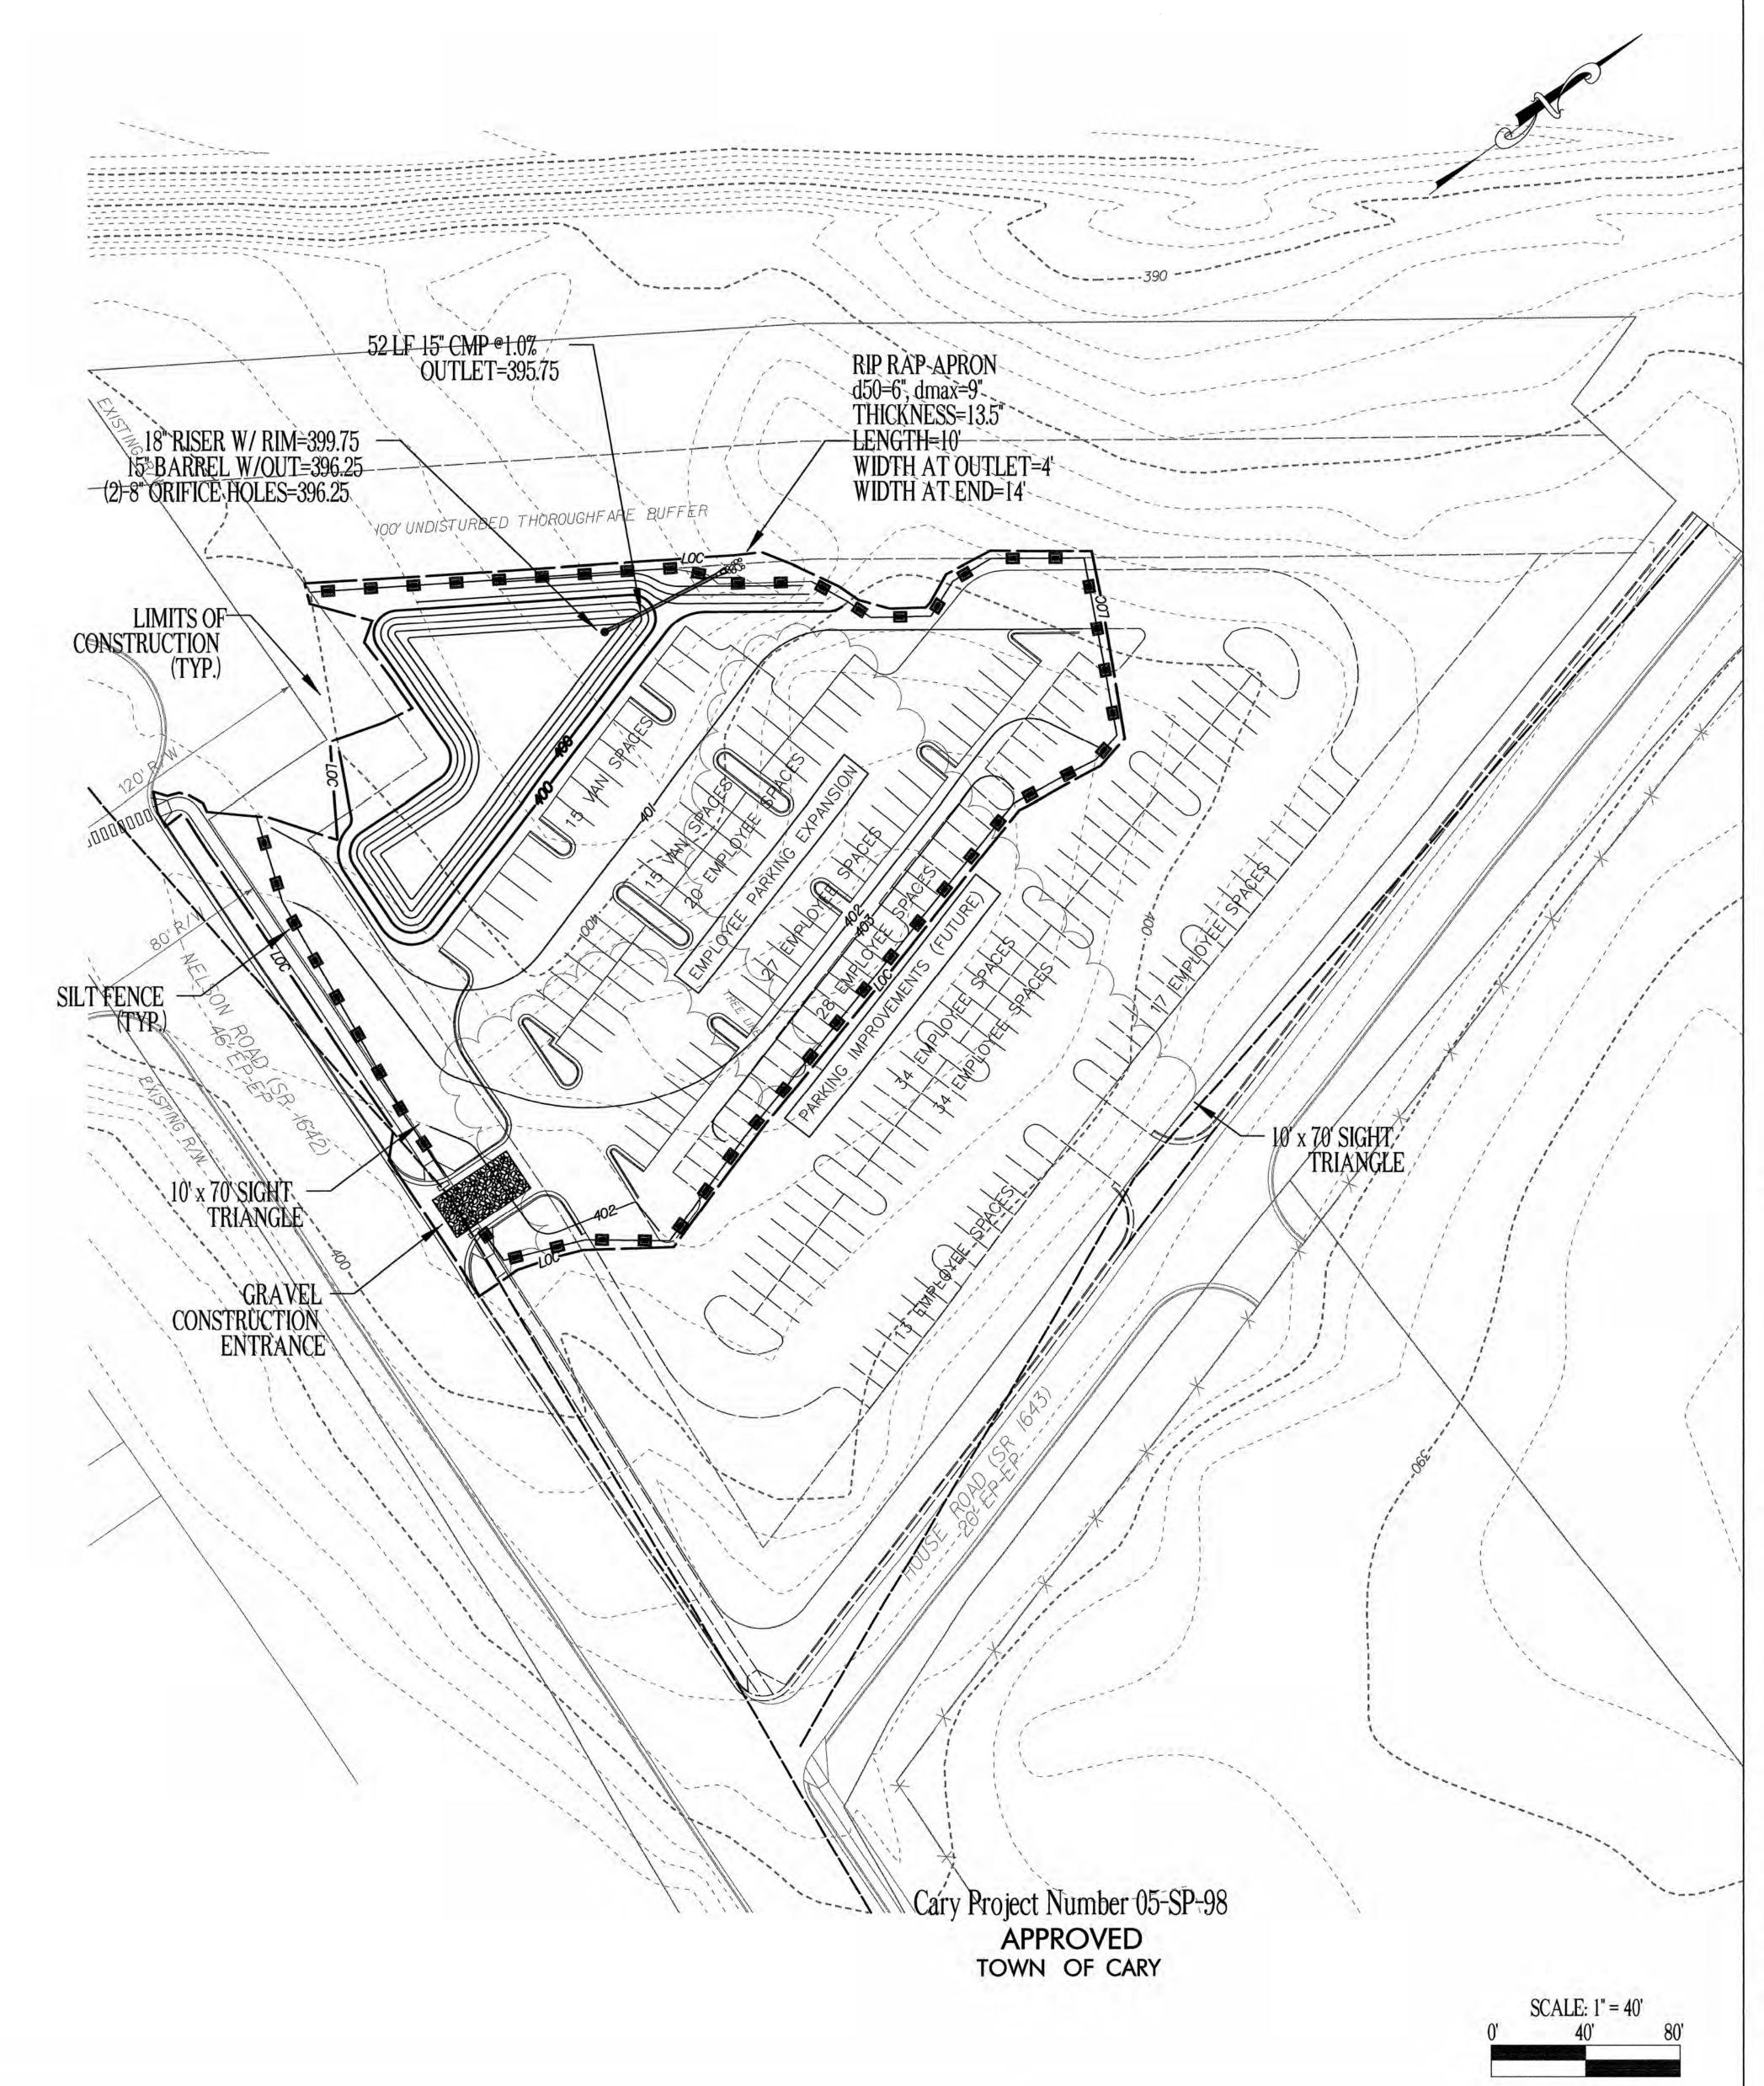
PAVEMENT MARKING PLAN

C-3c

### STORM DRAINAGE NOTES:

- 1. ALL PROPOSED DOWNSPOUTS ARE TO BE COLLECTED BY AN UNDERGROUND COLLECTION SYSTEM AND ROUTED INTO THE STORM DRAINAGE SYSTEM.
- 2. ALL PROPOSED STORM DRAINAGE WILL BE ROUTED THROUGH THE EXISTING OIL/WATER SEPARATORS PRIOR TO DISCHARGING INTO THE EXISTING POND.
- 3. TO MINIMIZE DAMAGE TO EXISTING TREES NEAR THE INTERIOR EDGE OF BUFFERS AND STREETSCAPES, THE CONTRACTOR SHALL CUT MINIMUM 2'TRENCHES ALONG THE LIMITS OF DISTURBANCE, SO AS TO CUT, RATHER THAN TEAR, ROOTS.
- 4. THE TREE PROTECTION FENCE SHALL BE MAINTAINED ON THE SITE UNTIL ALL SITE WORK IS COMPLETED AND THE FINAL SITE INSPECTION PRIOR TO THE CERTIFICATE OF OCCUPANCY (CO) IS SCHEDULED. THE FENCING SHALL BE REMOVED PRIOR TO THE FINAL SITE INSPECTION FOR THE CO.
- 5. PROPOSED DENUDED AREA = 3.18 AC.
- 6. ALL PERMANENT GROUND COVER WILL BE ESTABLISHED IN 15 WORKING DAYS, OR 90 CALENDAR DAYS, WHICH EVER IS SHORTER.
- 7. THERE ARE NO EXISTING WETLAND AREAS WITHIN THIS PROJECT.
- 8. ALL STORM DRAIN FRAMES, GRATES & HOODS SHALL BE STAMPED WITH "DRAINS TO RIVER" IN ACCORDANCE WITH TOWN OF CARY STANDARDS.
- 9. THIS PROJECT IS WITHIN THE NEUSE RIVER WATERSHED CRABTREE CREEK (UPPER) DRAINAGE BASIN.

  10. THERE ARE NO EXISTING FLOOD PLAINS WITHIN THIS PROJECT.
- 11. THE STREETS IN FRONT OF THE PROJECT WILL BE KEPT CLEAN AT ALL TIMES OR A WASH STATION WILL BE REQUIRED.
- 12. EROSION CONTROL REVIEW AND INSPECTION WILL BE ADDRESSED BY THE NORTH CAROLINA DEPARTMENT OF ENVIRONMENT, HEALTH AND NATURAL RESOURCES.
- 13. THIS PROJECT WILL NOT BE APPROVED BY THE TOWN OF CARY UNTIL NOTIFICATION HAS BEEN RECEIVED FROM THE ECOSYSTEM ENHANCEMENT PROGRAM THAT A RECEIPT HAS BEEN ISSUED TO THE DEVELOPER AND THE LOCAL GOVERNMENT STATING THAT THE NITROGEN BUYDOWN HAD BEEN COMPLETED.
- 14. THIS PROJECT SHALL MEET ALL OF THE REQUIREMENTS RELATIVE TO BEST MANAGEMENT PRACTICES AND ENGINEERED STORMWATER CONTROL STRUCTURES AS OUTLINED IN THE TOWN OF CARY UNIFIED DEVELOPMENT ORDINANCE (CHAPTER 7, PART 3.7, LDO).
- 15. MINIMUM CONCRETE FOOTING FOR 18" RISER BARREL = 3' x 3' x 1.5' THICK





NELSON ROAD CARY, NORTH CAROLINA



COMPLETE FACILITIES SOLUTIONS

MOSER MAYER PHOENIX

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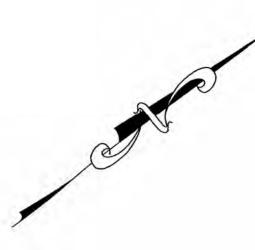




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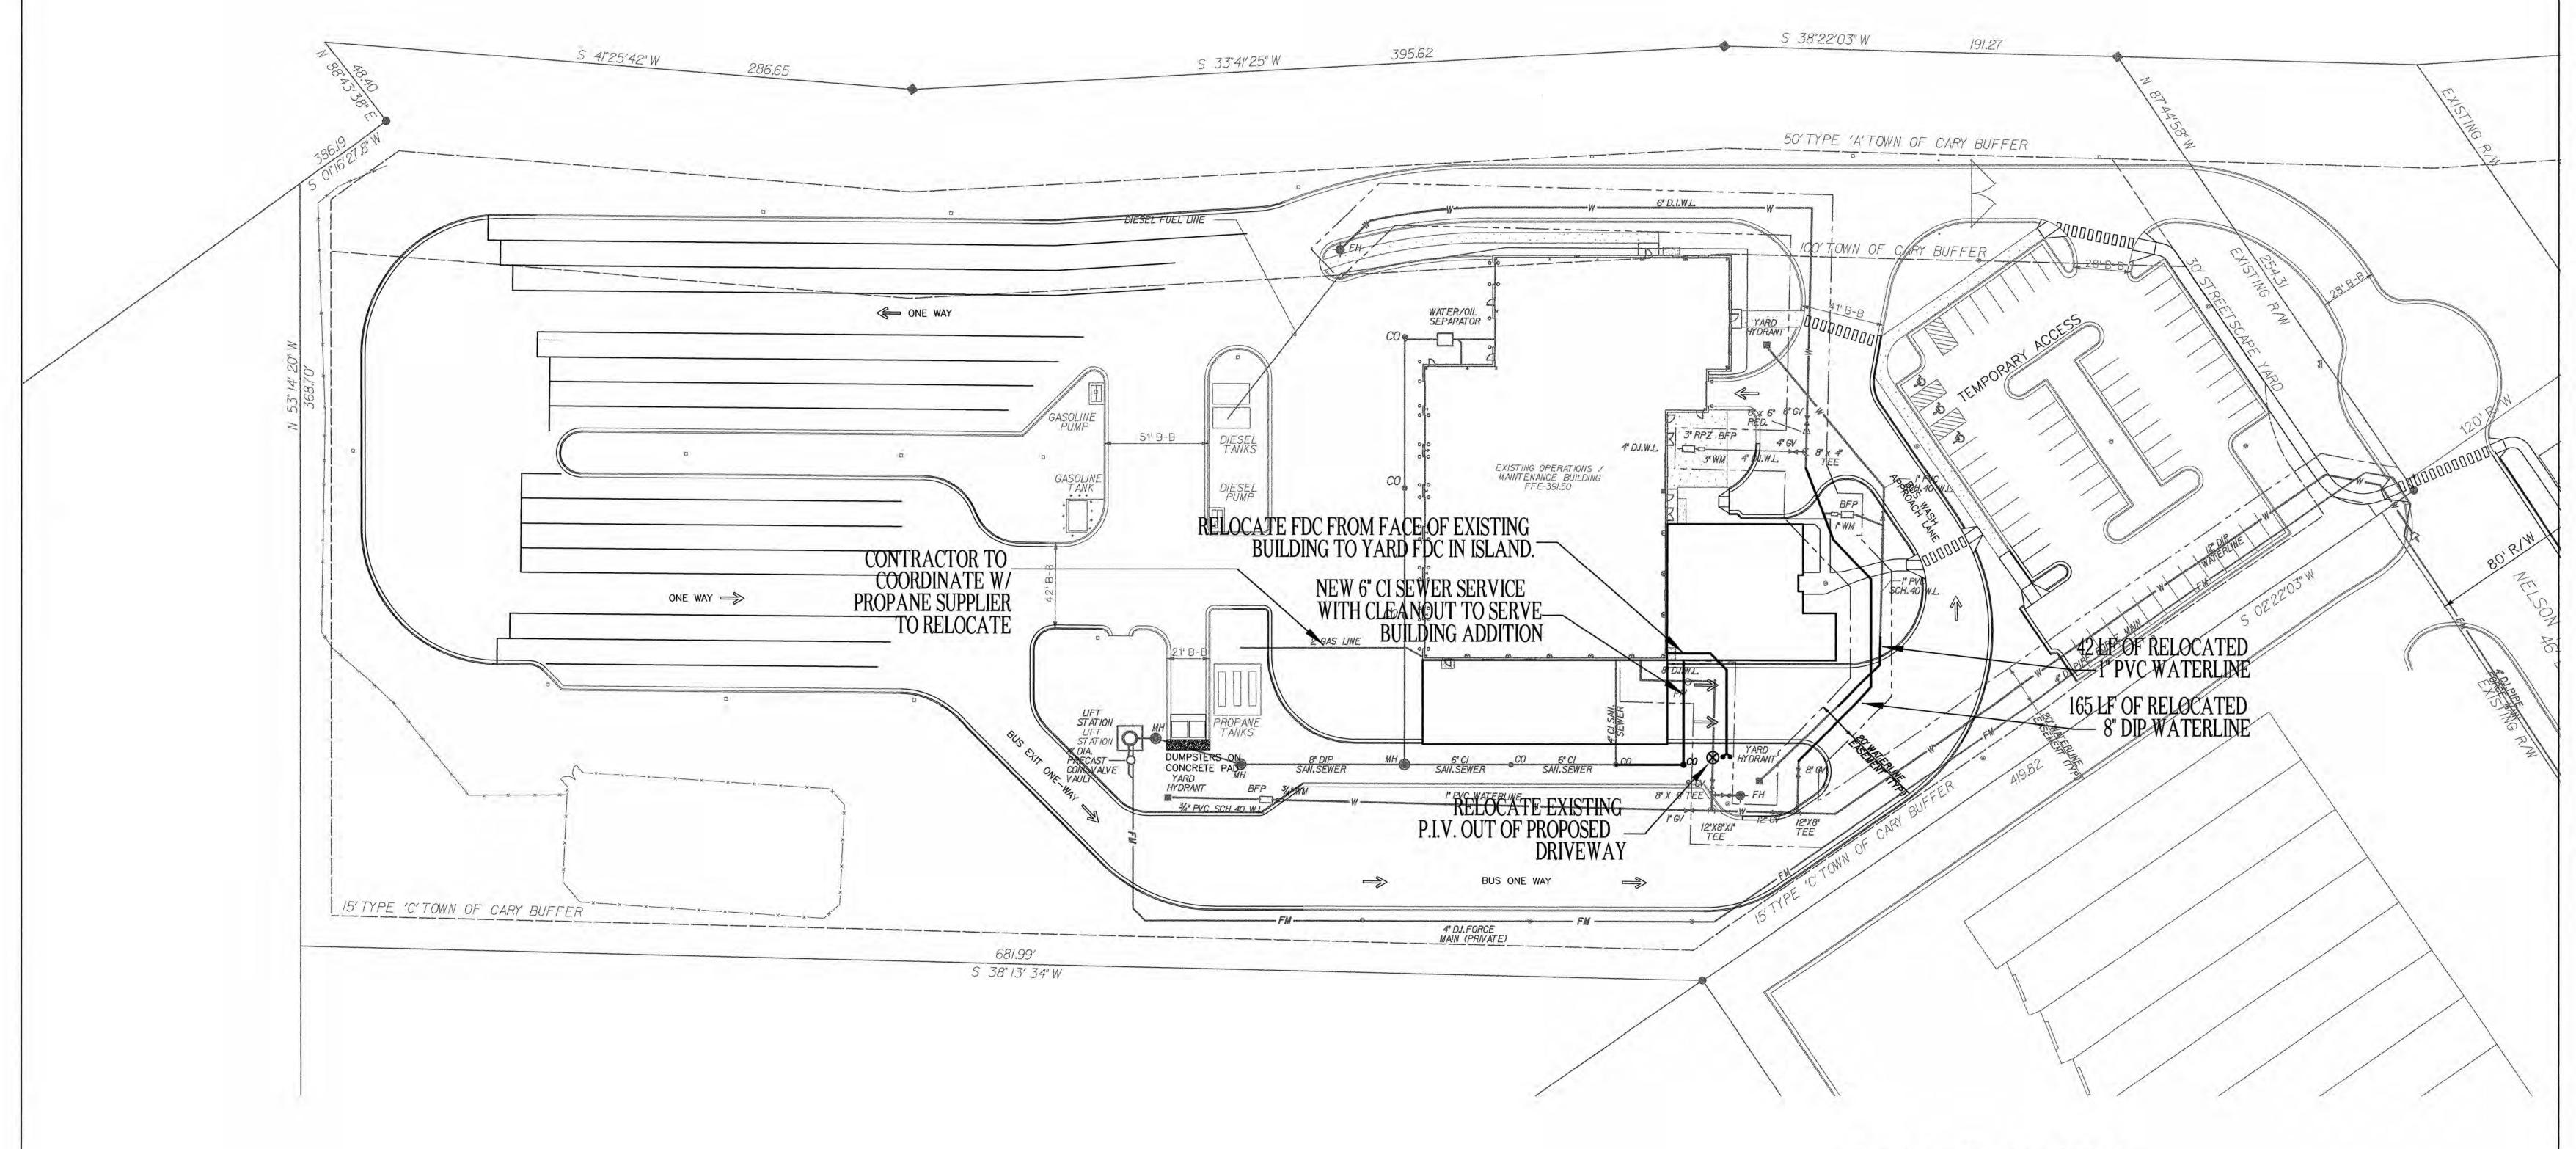
GRADING, STORM & EROSION PLAN VACANT LOT

C-4a



## UTILITY NOTES:

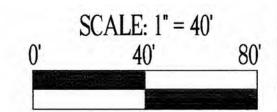
- 1. DOMESTIC WATER FOR THE PROPOSED ADDITIONS WILL BE PROVIDED INTERNALLY FROM THE EXISTING BUILDING.
- 2. A TOWN OF CARY WATERLINE PERMIT WILL BE REQUIRED FOR THIS PROJECT.
- 3. 165 L.F. OF 8" PUBLIC WATERLINE IS PROPOSED FOR THIS PROJECT.



Cary Project Number 05-SP-98

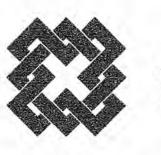
APPROVED

TOWN OF CARY





NELSON ROAD CARY, NORTH CAROLINA



COMPLETE FACILITIES SOLUTIONS

MOSER
MAYER

328 E. Market Street
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ASSOCIATES, PA

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	DRAWN BY	CMW

UTILITY PLAN

C-5

**GENERAL NOTES:** 

1. NO CHANGES TO ANY ASPECT OF THIS PLAN, INCLUDING BUT NOT LIMITED TO, LANDSCAPING, GRADING, BUILDING ELEVATIONS (ESPECIALLY COLORS), LIGHTING, OR UTILITIES WILL BE MADE WITHOUT THE APPROVAL OF THE DEVELOPMENT REVIEW GROUP OF THE DEPARTMENT OF PLANNING AND DEVELOPMENT.

2. THE SITE SHALL BE STABILIZED AND SEEDED PRIOR TO THE ISSUANCE OF A CERTIFICATE OF OCCUPANCY.

3. ALL HVAC SYSTEMS WILL BE SCREENED FROM OFF SITE VIEWS.

4. ALL DUMPSTER AND CARDBOARD RECYCLING LOCATIONS WILL BE SCREENED FROM OFF SITE VIEWS.

5. WHERE EXISTING VEGETATION FAILS TO FUNCTION ADEQUATELY AS REQUIRED, (I.E. BUFFER TYPE A, B, C, 30' STREETSCAPE BUFFER. THE CARY SITE INSPECTOR RESERVES THE RIGHT TO REQUIRE SUPPLEMENTAL PLANTINGS IN ADDITION TO THOSE SHOWN ON THE PLANTING PLAN BASED ON ACTUAL FIELD CONDITIONS.

6. ALL EXTERIOR SITE LIGHTING WILL BE DESIGNED TO PREVENT OFF SITE GLARE.

7. THE SIZE OF THE PLANTING AREA AND SIZE OF PLANT MATERIAL AT MATURITY SHALL ALLOW FOR A 2.5' BUMPER OVERHANG FROM THE BACK OF CURB.

8. NO TREE SHALL BE LOCATED WITHIN A ROADWAY RIGHT-OF-WAY OR WITHIN 5'OF A SIDEWALK.

9. NO TREE SHALL BE LOCATED WITHIN 10' OF A LIGHTING LOCATION.

10. ALL TREE PROTECTION FENCING SHALL BE MAINTAINED UNTIL ALL SITE WORK IS COMPLETED. THE FENCING SHALL BE REMOVED PRIOR TO THE FINAL SITE INSPECTION FOR THE CERITFICATE OF OCCUPANCY (CO).

11. ALL ABOVE GROUND UTILITY EQUIPMENT AND FACILITIES ASSOCIATED WITH ON SITE ELECTRIC, CABLE, TELEPHONE, GAS OR OTHER SIMILAR UTILITY SHALL BE IN THE SIDE OR REAR YARD & SHALL BE SCREENED, TO THE EXTENT POSSIBLE, WITH EVERGREEN PLANTINGS. PLANTINGS SHALL ALLOW FOR A MINIMUM OF A 5'CLEARANCE AROUND THE STRUCTURE TO ALLOW FOR ACCESS. ADDITIONALLY, ANY SIDE OF THE STRUCTURE HAVING A DOOR OR LOCK, THE PLANTINGS SHALL ALLOW FOR A 10'CLEARANCE. THE AMOUNT OF CLEARANCE SHALL ACCOUNT FOR THE SIZE OF THE PLANT MATERIAL AT MATURITY.

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15. ANY RETAINING WALLS ON THE SITE OVER 5' HIGH REQUIRE A BUILDING PERMIT. 16. ALL CONSTRUCTION MUST BE PERFORMED IN ACCORDANCE WITH CURRENT TOWN OF CARY STANDARD SPECIFICATIONS AND DETAILS. 17. ALL ADJACENT STREETS IN THE VICINITY OF THIS PROJECT SHALL BE KEPT CLEAN AT ALL TIMES WITH RESPECT TO CONSTRUCTION TRAFFIC. IF THEY ARE NOT, A WASH STATION WILL BE REQUIRED.

18. THE TREE PROTECTION FENCING SHALL BE INSTALLED AND INSPECTED PRIOR TO THE ISSUANCE OF A GRADING PERMIT FOR THIS PROJECT.

19. THIS PROJECT DRAINS TO AN UNNAMED TRIBUTARY OF STIRRUP IRON CREEK.

PROPOSED PUBLIC UTILITIES

8" WATERLINE

20. APPROVED, STAMPED AND SIGNED BUILDING ELEVATIONS FROM THIS SITE PLAN MUST BE INCORPORATED IN THE BUILDING PERMIT PLANS.

21. THE DEVELOPER WILL BE RESPONSIBLE FOR ALL INSTALLATION COSTS ASSOCIATED WITH STREET LIGHTING ALONG PROPOSED STREETS, ADJACENT STREETS AND THOROUGHFARES AS REQUIRED PER TOWN OF CARY POLICY STATEMENT NO. 13. THE DEVELOPER SHALL CONTACT PROGRESS ENERGY AFTER PLAN APPROVAL AND PRIOR TO CONSTRUCTION IN ORDER TO DEVELOP A STREET LIGHTING PLAN FOR THE SITE/SUBDIVISION PLANS.

22. PROPOSED DENUDED AREA = 3.18 AC. 23. BIKE RACKS WILL BE INCORPORATED INTO THE SITE IN CONFORMANCE WITH THE ASSOCIATION OF PEDESTRIAN AND BICYCLE PROFESSIONALS BICYCLE PARKING GUIDELINES ADOPTED SPRING

PAVEMENT SECTIONS REPLACE EXISTING PVMT. WITH NEW HEAVY DUTY

2.5" S9.5B 3.0" I19.0B 5.5" ASPHALT BASE (FOR BUS TRAFFIC AREAS) ON SUB-GRADE NEW HEAVY DUTY PVMT. SECTION (FOR BUS TRAFFIC 3.0" I19.0B

5.5" ASPHALT BASE ON SUB-GRADE PARKING LOT AISLES 2.5" S9.5B 8.0" ABC 2.5" S9.5B PARKING STALLS 6.0" ABC

SITE DATA

PROPERTY OWNER....RESEARCH TRIANGLE REGIONAL PUBLIC TRANSPORTATION AUTHORITY

PROPERTY ADDRESS....5201 NELSON ROAD (MAINT. SITE), 5210 NELSON ROAD (VACANT LOT) CARY PROJECT # 05-SP-098

PIN #....0245586 (MAINTENANCE SITE), 0092222 (VACANT LOT) ZONING....ORD (BOTH PARCELS)

5201 NELSON ROAD (MAINT. SITE) PRE-DEVELOPMENT: POST-DEVELOPMENT: TOTAL ACRES TOTAL ACRES

IMPERVIOUS ACRES 4.30 AC IMPERVIOUS ACRES 5.09 AC PERVIOUS ACRES 4.72 AC PERVIOUS ACRES 3.93 AC %IMPERVIOUS %IMPERVIOUS 47.7% 56.4% 5210 NELSON ROAD (VACANT LOT) PRE-DEVELOPMENT: POST-DEVELOPMENT: TOTAL ACRES TOTAL ACRES 4.81 AC

IMPERVIOUS ACRES 0.00 AC PERVIOUS ACRES 4.81 AC %IMPERVIOUS 0.00%

PARKING (OVERFLOW LOT) PARKING (MAIN COMPLEX)

IMPERVIOUS ACRES

PERVIOUS ACRES

%IMPERVIOUS

1.78 AC

3.03 AC

36.9%

EMPLOYEE: EXISTING TO REMAIN: PHASE 1B PROPOSED SPACES: 47
FUTURE SPACES: 126 PROPOSED SPACES: TOTAL: TOTAL: HANDICAP SPACES:

PHASE 1B PROPOSED SPACES: FUTURE SPACES: **BUS PARKING:** VAN PARKING: TOTAL: TOTAL BUS/VAN:

**NOTES** 

These notes set forth here shall apply to each and every sheet.

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The Underground Damage Prevention Act.

**EXISTING GROSS FLOOR AREA:** 15,726 SF PROPOSED GROSS FLOOR AREA: 2,737 SF 18,463 SF TOTAL GROSS FLOOR AREA: PARKING SPACES REQ. (1/200 SF): 92 SPACES

PARKING SPACES PROVIDED: 106 SPACES (EXISTING + PHASE 1B)

FACILITIES SOLUTIONS MOSER 328 E. Market Street PHOENIX Greensboro, N. C. 27401
Telephone 336-373-9800

ASSOCIATES, PA

ADDITIONS TO

MAINTENANCE

COMPLETE

**FACILITY** 

CARY, NORTH CAROLINA

NELSON ROAD

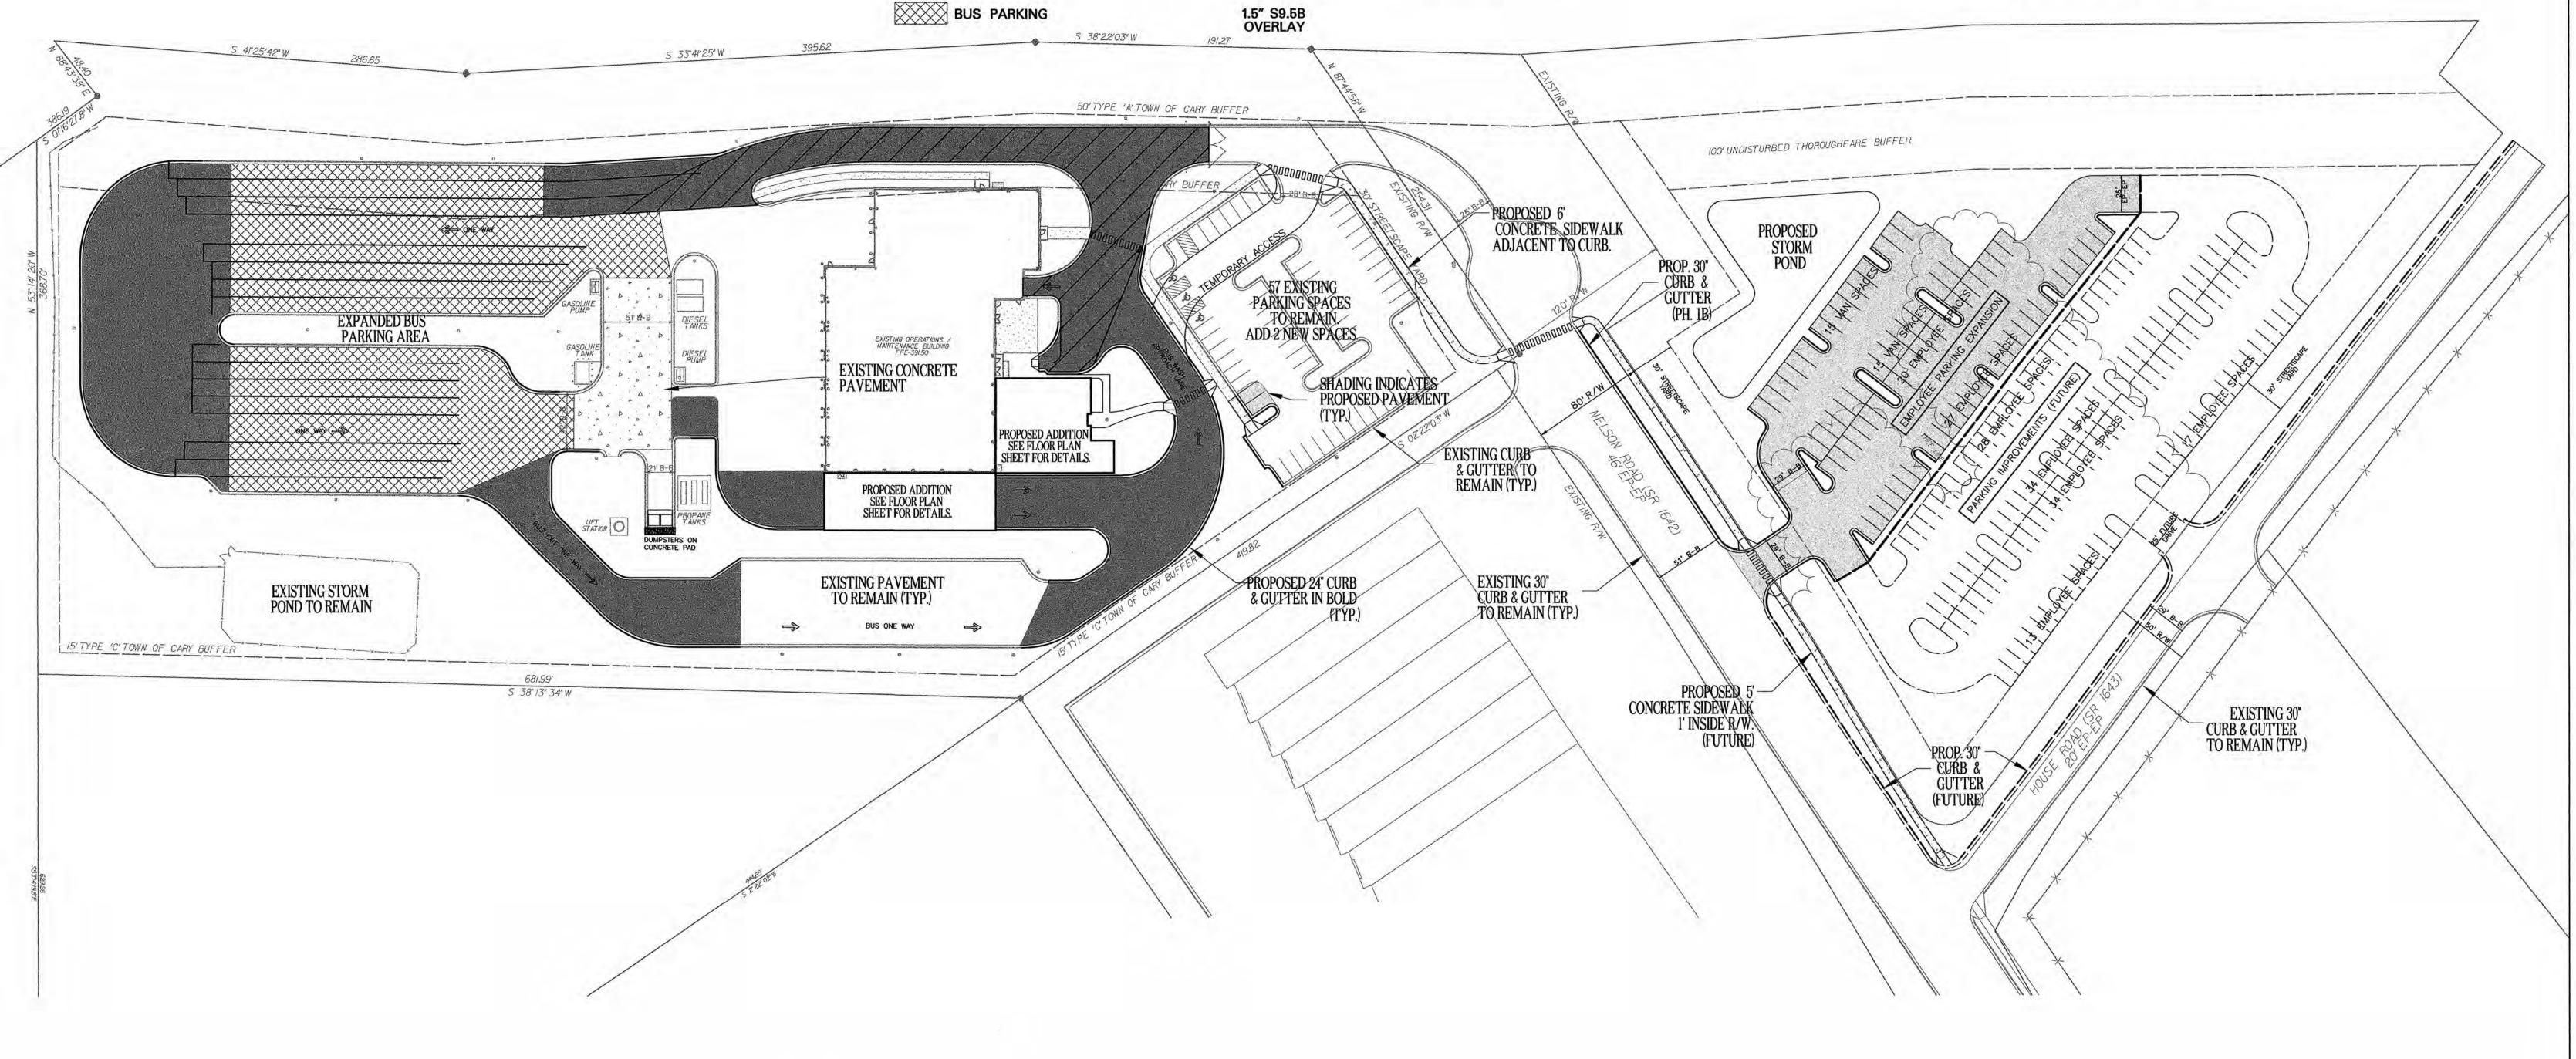
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		REVISIONS
NO.	DATE	DESCRIPTION
1	04-28-06	FINAL CONSTRUCTION DRAWINGS
,	DATE	06-09-05
PF	ROJECT NO.	2005141.00
	SCALE	1" = 60'
	DRAWN BY	

PAVING PLAN



Cary Project Number 05-SP-98 APPROVED TOWN OF CARY

SCALE: 1" = 60'

GENERAL NOTES:

1. NO CHANGES TO ANY ASPECT OF THIS PLAN, INCLUDING BUT NOT LIMITED TO, LANDSCAPING, GRADING, BUILDING ELEVATIONS (ESPECIALLY COLORS), LIGHTING, OR UTILITIES WILL BE MADE WITHOUT THE APPROVAL OF THE DEVELOPMENT REVIEW GROUP OF THE DEPARTMENT OF PLANNING AND DEVELOPMENT.

2. THE SITE SHALL BE STABILIZED AND SEEDED PRIOR TO THE ISSUANCE OF A CERTIFICATE OF OCCUPANCY. 3. ALL HVAC SYSTEMS WILL BE SCREENED FROM OFF SITE VIEWS.

4. ALL DUMPSTER AND CARDBOARD RECYCLING LOCATIONS WILL BE SCREENED FROM OFF SITE VIEWS.

5. WHERE EXISTING VEGETATION FAILS TO FUNCTION ADEQUATELY AS REQUIRED, (I.E. BUFFER TYPE A, B, C, 30' STREETSCAPE BUFFER. THE CARY SITE INSPECTOR RESERVES THE RIGHT TO REQUIRE SUPPLEMENTAL PLANTINGS IN ADDITION TO THOSE SHOWN ON THE PLANTING PLAN BASED ON ACTUAL FIELD CONDITIONS.

7. THE SIZE OF THE PLANTING AREA AND SIZE OF PLANT MATERIAL AT MATURITY SHALL ALLOW FOR A 2.5' BUMPER OVERHANG FROM THE BACK OF CURB.

8. NO TREE SHALL BE LOCATED WITHIN A ROADWAY RIGHT-OF-WAY OR WITHIN 5' OF A SIDEWALK.

9. NO TREE SHALL BE LOCATED WITHIN 10' OF A LIGHTING LOCATION.

6. ALL EXTERIOR SITE LIGHTING WILL BE DESIGNED TO PREVENT OFF SITE GLARE.

10. ALL TREE PROTECTION FENCING SHALL BE MAINTAINED UNTIL ALL SITE WORK IS COMPLETED, THE FENCING SHALL BE REMOVED PRIOR TO THE FINAL SITE INSPECTION FOR THE CERITFICATE OF OCCUPANCY (CO). 11. ALL ABOVE GROUND UTILITY EQUIPMENT AND FACILITIES ASSOCIATED WITH ON SITE ELECTRIC, CABLE, TELEPHONE, GAS OR OTHER SIMILAR UTILITY SHALL BE IN THE SIDE OR REAR YARD & SHALL BE SCREENED, TO THE EXTENT POSSIBLE, WITH EVERGREEN PLANTINGS. PLANTINGS SHALL ALLOW FOR A MINIMUM OF A 5'CLEARANCE AROUND THE STRUCTURE TO ALLOW FOR ACCESS. ADDITIONALLY, ANY SIDE OF THE STRUCTURE HAVING A DOOR OR LOCK, THE PLANTINGS SHALL ALLOW FOR A 10'CLEARANCE. THE AMOUNT OF CLEARANCE SHALL ACCOUNT FOR THE SIZE OF THE PLANT MATERIAL AT MATURITY.

12. ALL VEHICULAR USE AREAS (DRIVES AND PARKING AREAS) SHALL BE SCREENED FROM OFFSITE VIEWS. 13. ALL SITE CONSTRUCTION MUST BE PERFORMED IN ACCORDANCE WITH CURRENT TOWN OF CARY STANDARD SPECIFICATIONS AND DETAILS AND ALL ROADWAY CONSTRUCTION WITH CURRENT NCDOT STANDARDS AND SPECIFICATIONS. 14. ALL WORK MUST COMPLY WITH NC STATE BUILDING AND HANDICAPPED ACCESSIBILITY CODE VOL 1C.

15. ANY RETAINING WALLS ON THE SITE OVER 5'HIGH REQUIRE A BUILDING PERMIT. 16. ALL CONSTRUCTION MUST BE PERFORMED IN ACCORDANCE WITH CURRENT TOWN OF CARY STANDARD SPECIFICATIONS AND DETAILS. 17. ALL ADJACENT STREETS IN THE VICINITY OF THIS PROJECT SHALL BE KEPT CLEAN AT ALL TIMES WITH RESPECT TO CONSTRUCTION TRAFFIC. IF THEY ARE NOT, A WASH STATION WILL BE REQUIRED.

18. THE TREE PROTECTION FENCING SHALL BE INSTALLED AND INSPECTED PRIOR TO THE ISSUANCE OF A GRADING PERMIT FOR THIS PROJECT.

19. THIS PROJECT DRAINS TO AN UNNAMED TRIBUTARY OF STIRRUP IRON CREEK.

22. PROPOSED DENUDED AREA = 3.18 AC.

20. APPROVED, STAMPED AND SIGNED BUILDING ELEVATIONS FROM THIS SITE PLAN MUST BE INCORPORATED IN THE BUILDING PERMIT PLANS.

21. THE DEVELOPER WILL BE RESPONSIBLE FOR ALL INSTALLATION COSTS ASSOCIATED WITH STREET LIGHTING ALONG PROPOSED STREETS, ADJACENT STREETS AND THOROUGHFARES AS REQUIRED PER TOWN OF CARY POLICY STATEMENT NO. 13. THE DEVELOPER SHALL CONTACT PROGRESS ENERGY AFTER PLAN APPROVAL AND PRIOR TO CONSTRUCTION IN ORDER TO DEVELOP A STREET LIGHTING PLAN FOR THE SITE/SUBDIVISION PLANS.

23. BIKE RACKS WILL BE INCORPORATED INTO THE SITE IN CONFORMANCE WITH THE ASSOCIATION OF PEDESTRIAN AND BICYCLE PROFESSIONALS BICYCLE PARKING GUIDELINES ADOPTED SPRING

PAVEMENT SECTIONS

REPLACE EXISTING PVMT. 2.5" S9.5B 3.0" I19.0B WITH NEW HEAVY DUTY PROPOSED PUBLIC UTILITIES (FOR BUS TRAFFIC AREAS) 5.5" ASPHALT BASE ON SUB-GRADE 8" WATERLINE NEW HEAVY DUTY PVMT. 2.5" S9.5B SECTION (FOR BUS TRAFFIC 3.0" I19.0B 5.5" ASPHALT BASE ON SUB-GRADE

PHASE 1B: NEW EMPLOYEE PARKING AREA:

PHASE 2: BUILDING, PARKING, AND DRIVE EXPANSION, TEMPORARY

PHASE 3A: RECONSTRUCTION OF EXISTING BUS DRIVE:

270 DAYS FROM FINAL COMPLETION AND OWNER ACCEPTANCE OF PHASE 1B

30 DAYS FROM FINAL COMPLETION AND OWNER ACCEPTANCE OF PHASE 2

PHASE 3B: REMOVAL AND REPAIR OF TEMPORARY ACCESS: 21 DAYS FROM FINAL COMPLETION AND OWNER ACCEPTANCE OF PHASE 3A

90 DAYS FROM NOTICE TO PROCEED

ACCESS CONSTRUCTION:

PARKING LOT AISLES PARKING STALLS

SITE DATA

PROPERTY OWNER....RESEARCH TRIANGLE REGIONAL PUBLIC TRANSPORTATION AUTHORITY

47.7%

0.00 AC

4.81 AC

0.00%

PROPERTY ADDRESS....5201 NELSON ROAD (MAINT. SITE), 5210 NELSON ROAD (VACANT LOT) CARY PROJECT # 05-SP-098 PIN #....0245586 (MAINTENANCE SITE), 0092222 (VACANT LOT) ZONING....ORD (BOTH PARCELS)

5201 NELSON ROAD (MAINT. SITE) POST-DEVELOPMENT: PRE-DEVELOPMENT: TOTAL ACRES TOTAL ACRES 9.02 AC IMPERVIOUS ACRES 4.30 AC IMPERVIOUS ACRES 5.09 AC PERVIOUS ACRES 4.72 AC PERVIOUS ACRES 3.93 AC %IMPERVIOUS %IMPERVIOUS

5210 NELSON ROAD (VACANT LOT) PRE-DEVELOPMENT: TOTAL ACRES IMPERVIOUS ACRES

PERVIOUS ACRES

%IMPERVIOUS

2.5" S9.5B

8.0" ABC

POST-DEVELOPMENT: TOTAL ACRES 4.81 AC IMPERVIOUS ACRES 1.78 AC PERVIOUS ACRES 3.03 AC %IMPERVIOUS

36.9%

Cary Project Number 05-SP-98

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TOWN OF CARY

TEMPORARY ACCESS:

THE CONTRACTOR WILL CONSTRUCT A TEMPORARY BUS ACCESS ROAD DURING PHASE 2 WHICH WILL BE UTILIZED DURING PHASE 3A TO ALLOW BUSES TO ACCESS THE REAR OF THE FACILITY. THE CONTRACTOR WILL REMOVE THE CURB AND GUTTER WITHIN THE TEMPORARY ACCESS AND INSTALL ADDITIONAL PAVEMENT AS NECESSARY. SOME MINIMAL GRADING MAY BE REQUIRED. ONCE PHASE 3A HAS BEEN COMPLETED, THE CONTRACTOR SHALL REMOVE THE TEMPORARY ACCESS ROAD AND RESTORE THE AREA BACK TO ORIGINAL CONDITIONS, INCLUDING THE INSTALLATION OF CURB, GUTTER **NOTES** 

All site construction shall be in accordance with Town of Cary standards and specifications details and all road construction shall be per NCDOT Standards and Specifications details.

The Engineer does not guarantee that all existing facilities such as pipelines, electrical lines, conduit, telephone cable, service connections, or other facilities are shown on the plans. It shall be the Contractor's responsibility to have all utilities located by their respective owners, field mark the utility locations, and protect all such existing facilities prior to beginning construction. The Contractor is fully responsible for notifying all utility owners in accordance with NC General Statute - Chapter 87, Article 8, The Underground Damage Prevention Act.

> COMPLETE FACILITIES SOLUTIONS

ADDITIONS TO

**MAINTENANCE** 

NELSON ROAD

CARY, NORTH CAROLINA

MOSER 328 E. Market Street Suite 200 Greensboro, N. C. 27401 Telephone 336-373-9800 Fax 336-373-0077 ASSOCIATES, PA

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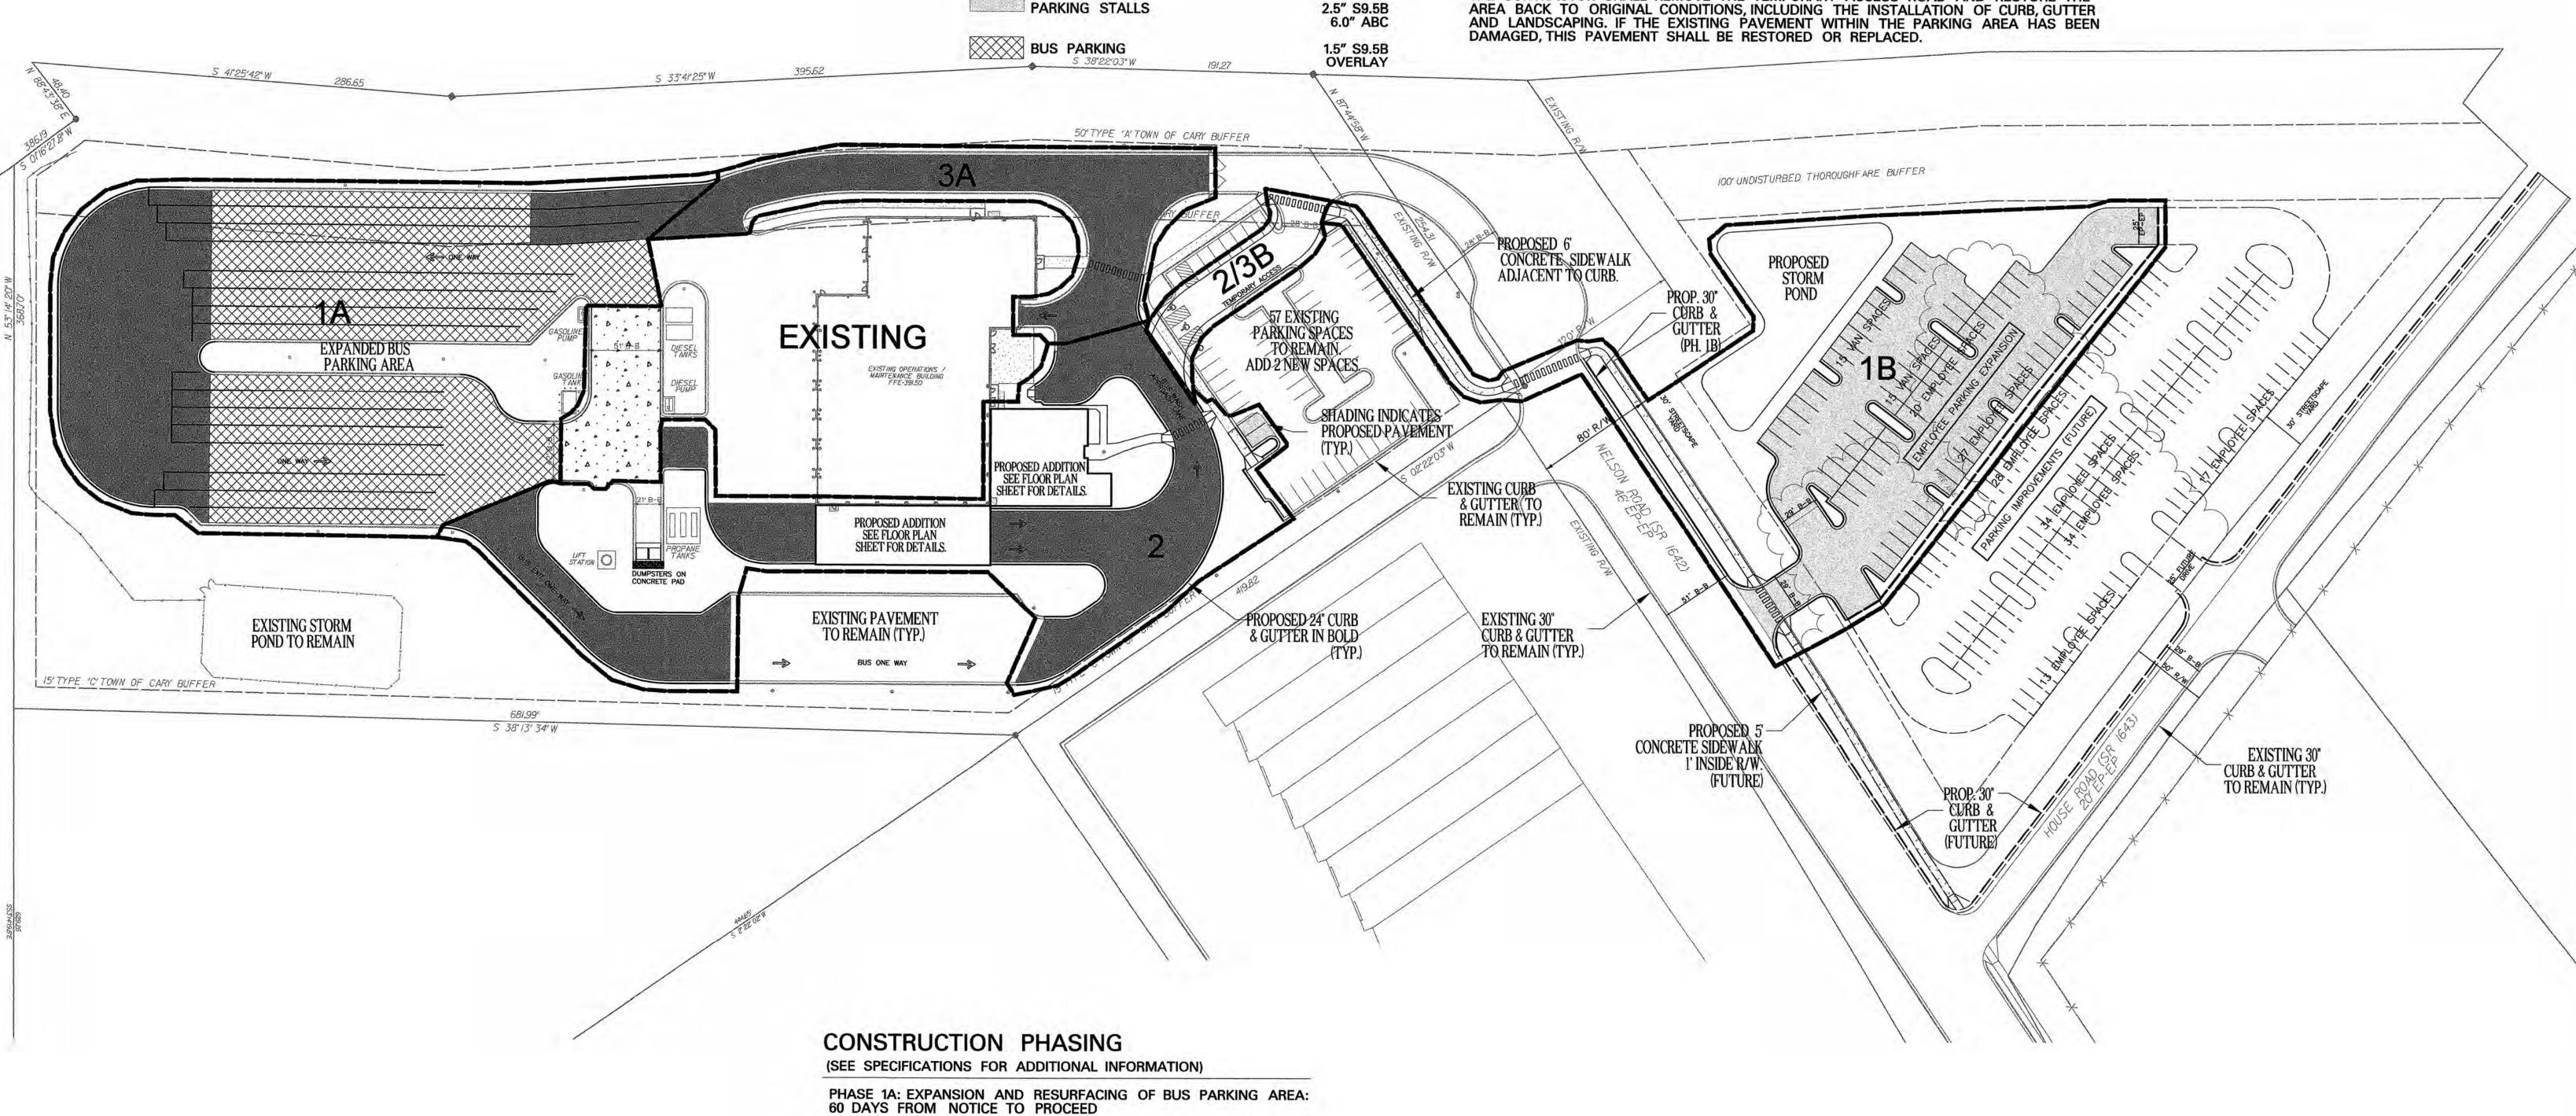
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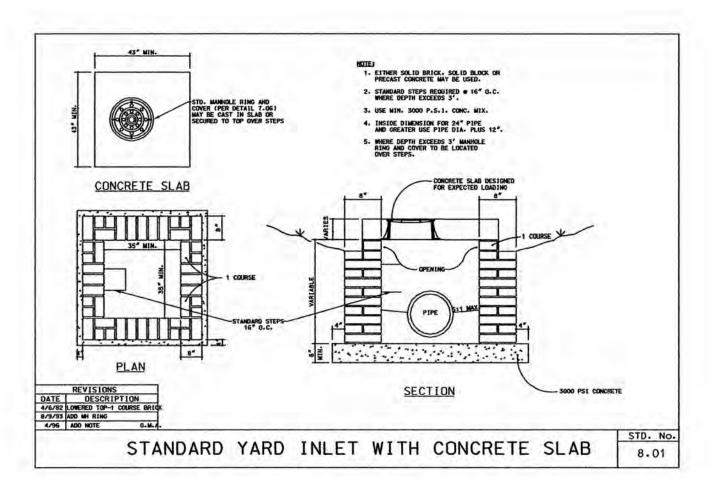


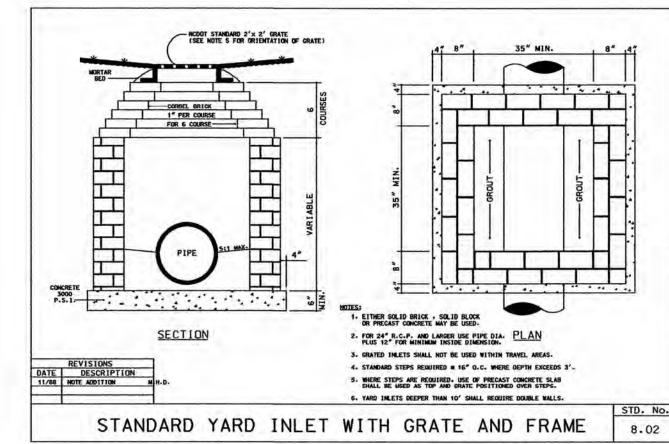
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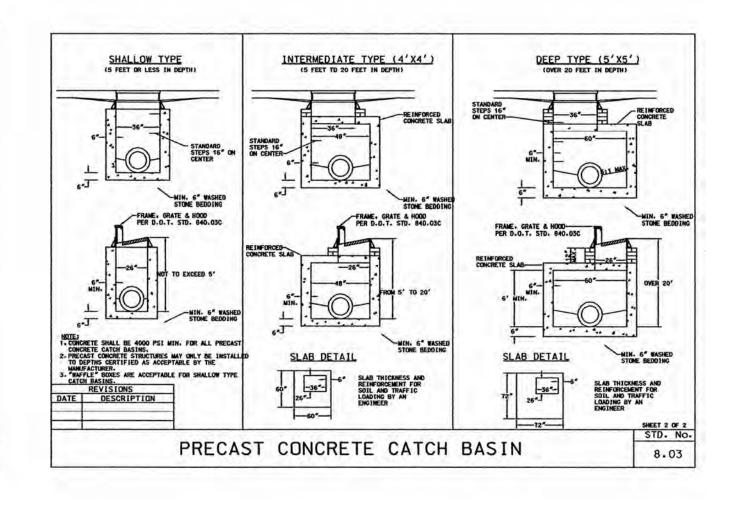
CONSTRUCTION PHASING PLAN

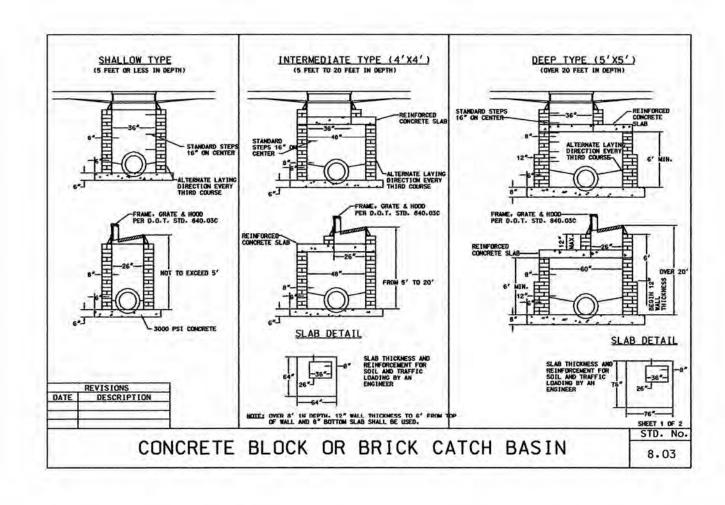
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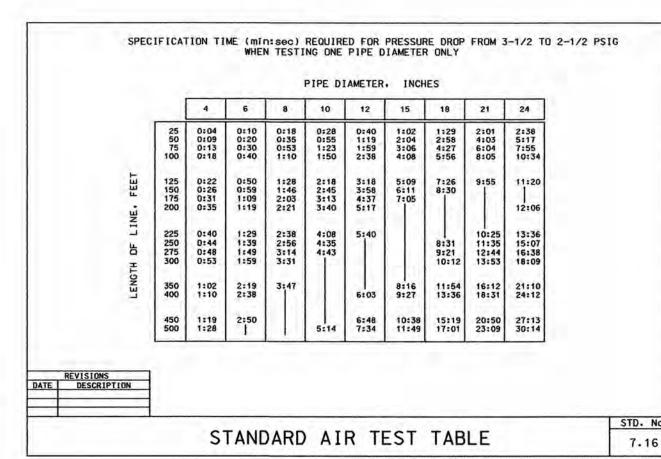


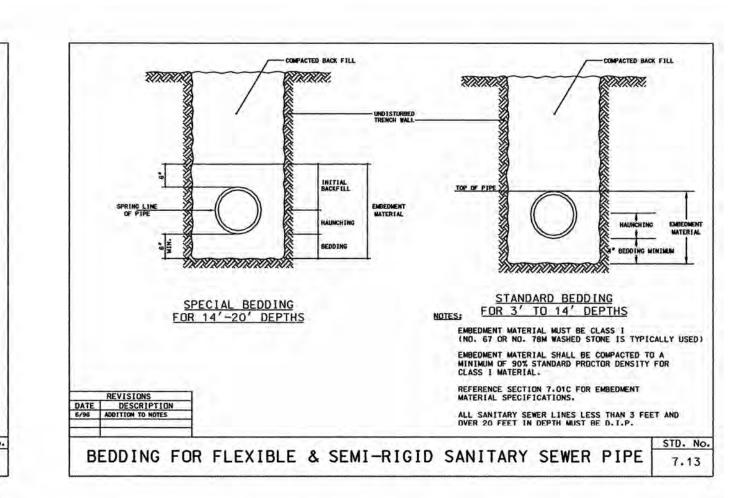


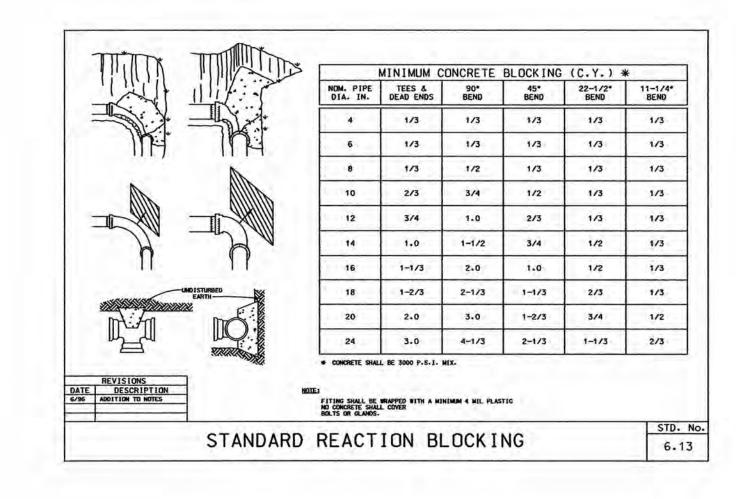


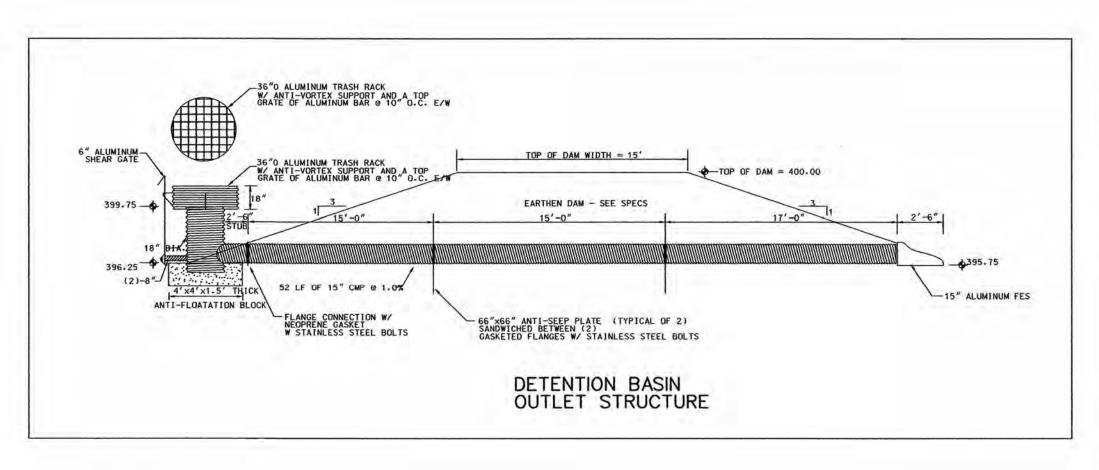


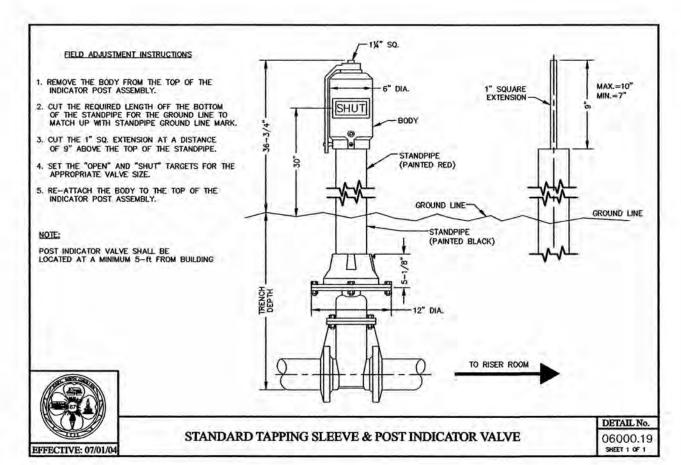


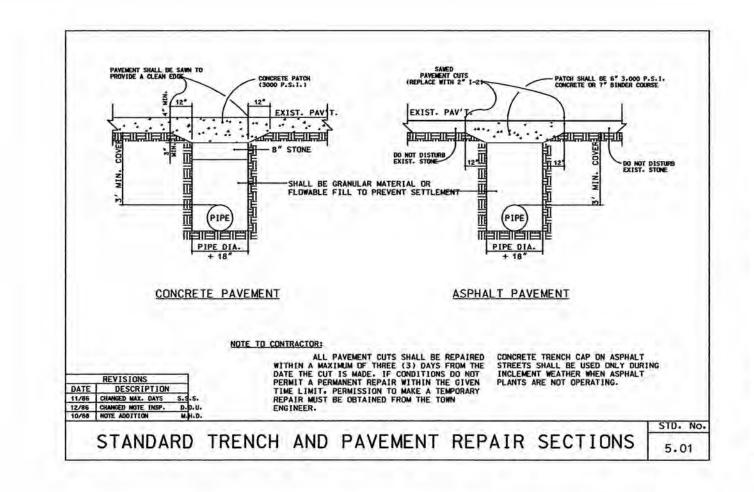


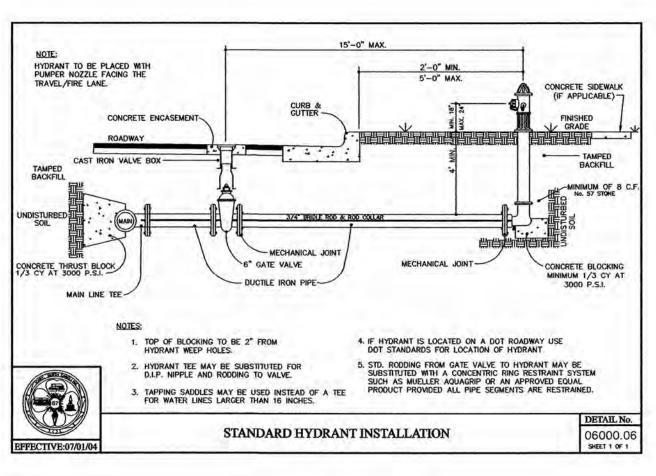


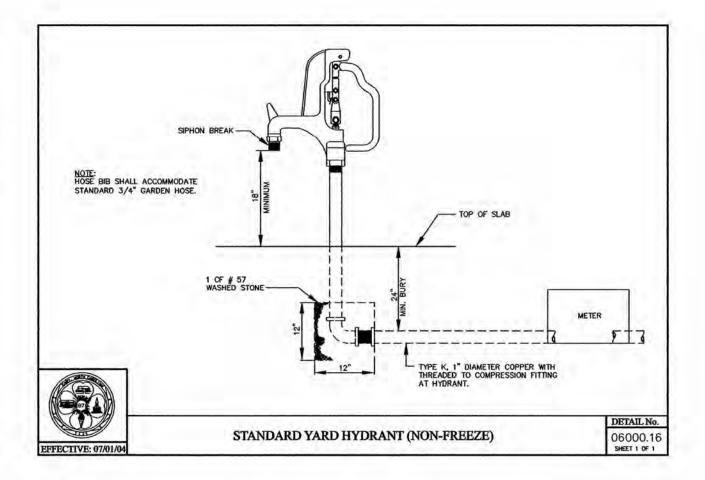


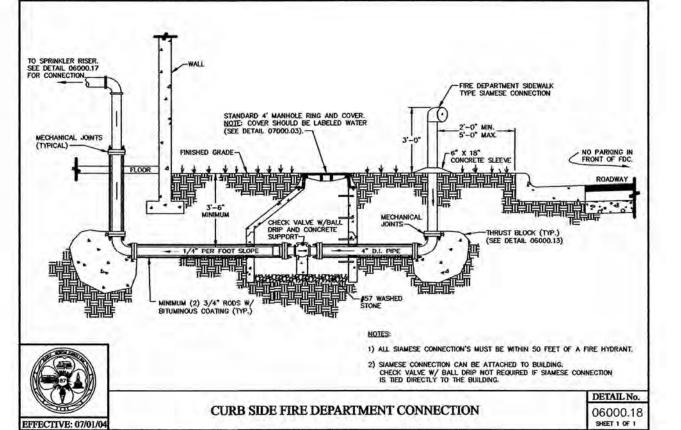












Cary Project Number 05-SP-98

APPROVED

TOWN OF CARY



NELSON ROAD CARY, NORTH CAROLINA



MOSER
MAYER

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ASSOCIATES, PA

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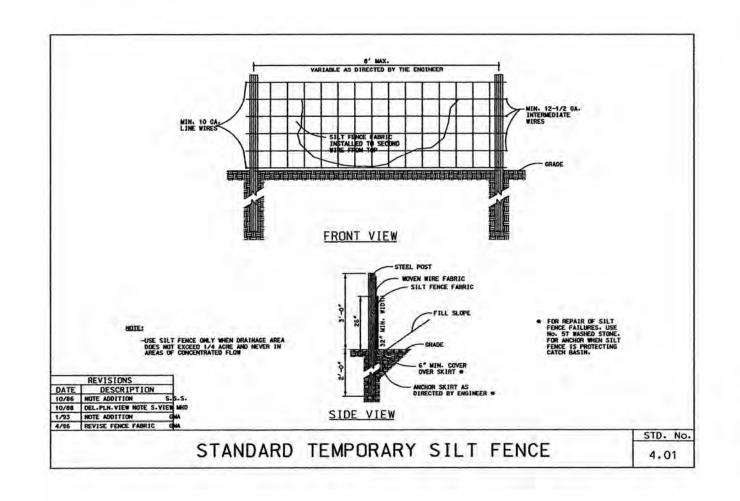


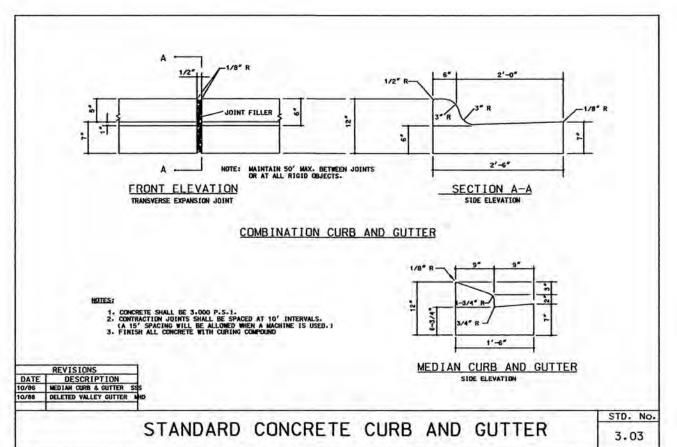


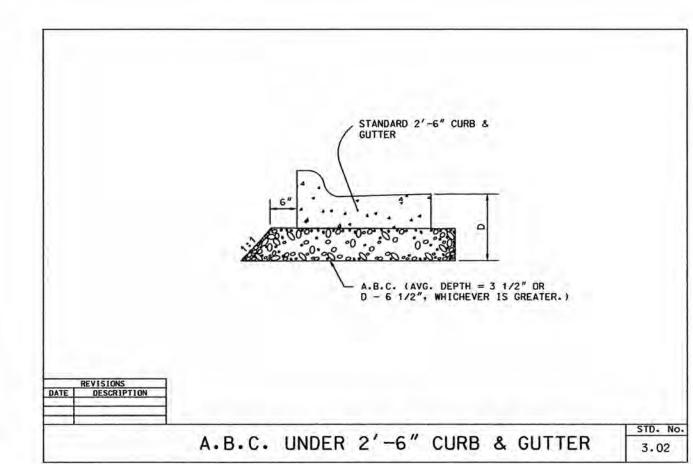
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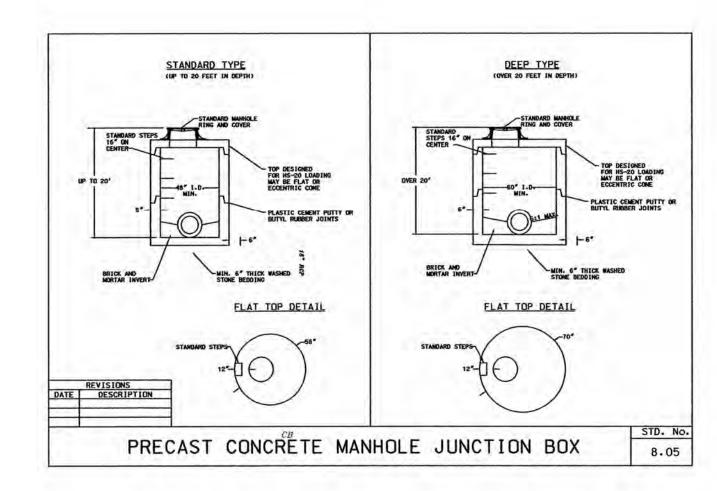
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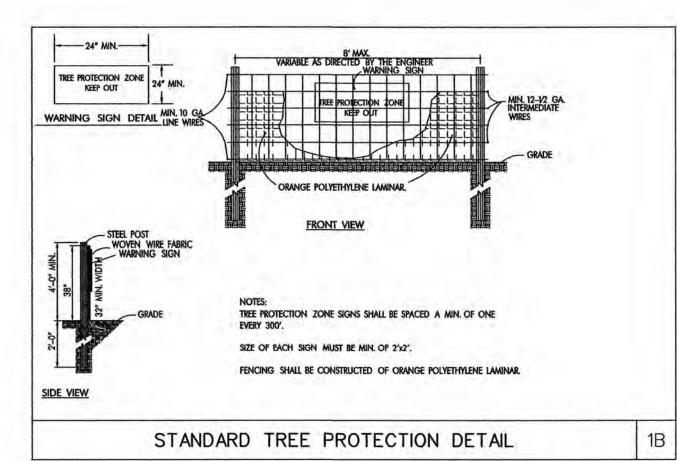
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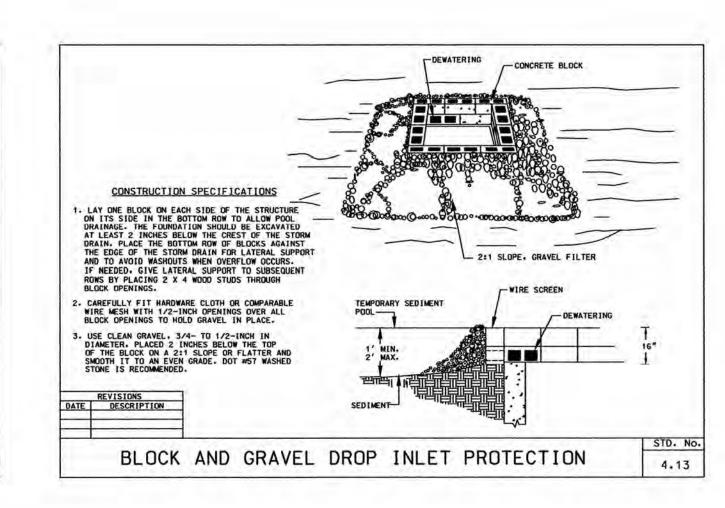


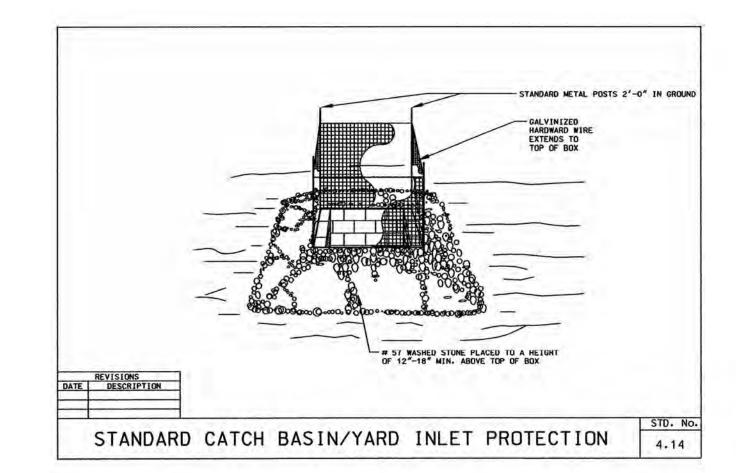


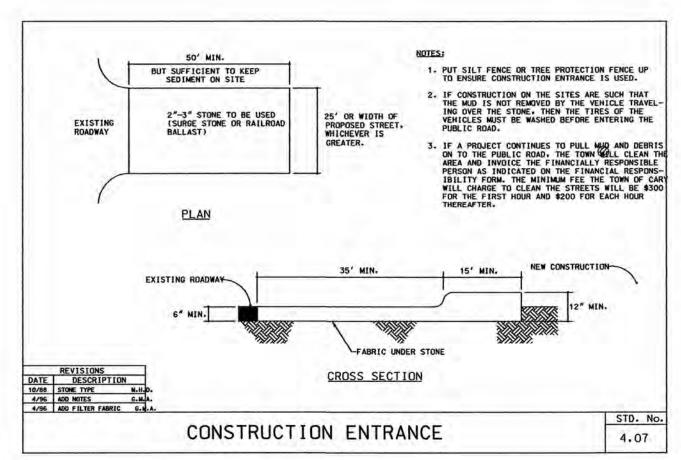


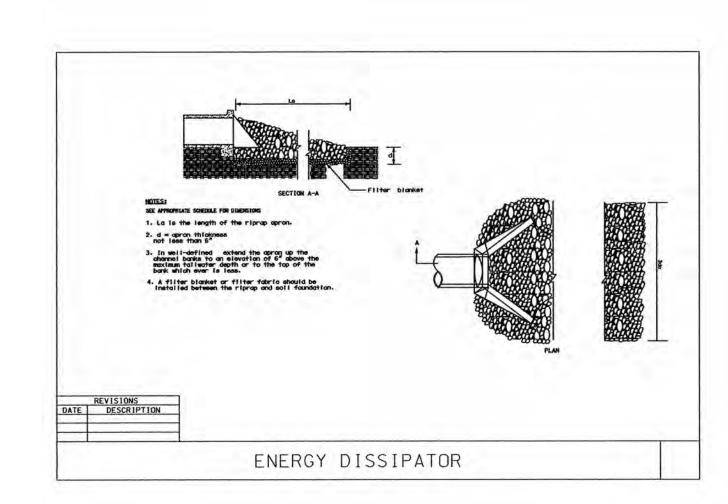












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TOWN OF CARY

NOTE: ALL STORM DRAINAGE FRAMES, GRATES AND HOODS SHALL BE STAMPED WITH "DRAINS TO RIVER" IN ACCORDANCE WITH TOWN OF CARY STANDARDS.

### CONSTRUCTION SEQUENCE

1. OBTAIN A LAND-DISTURBING PERMIT.
2. INSTALL GRAVEL CONSTRUCTION ENTRANCES(S), SILT FENCE,
TREE PROTECTION FENCE, INSTALLATION OF DETENTION

POND AND OR OTHER MEASURES AS SHOWN ON THE ADDROV

POND, AND/OR OTHER MEASURES AS SHOWN ON THE APPROVED PLAN AND ANY SPECIAL CONDITIONS NOTED IN "LETTER OF APPROVAL."

3. CALL THE TOWN OF CARY FOR ON SITE INSPECTION BY THE SEDIMENTATION AND EROSION CONTROL OFFICE AND NOTIFICATION

4. BEGIN CLEARING, GRUBBING, AND GRADING. MAINTAIN MEASURES AS REQUIRED.
STRIP EXISTING TOPSOIL AND SET ASIDE FOR USE DURING SEEDBED PREPARATION
5. GRADED SLOPES AND FILLS ARE TO BE PLANTED OR PROVIDED WITH

PROTECTIVE COVER SUFFICIENT TO RESTRAIN EROSION WITHIN 21 CALENDAR DAYS AFTER THE COMPLETION OF ANY PHASE OF GRADING. ALL AREAS UPON WHICH NO FURTHER LAND DISTURBING ACTIVITY WILL BE UNDERTAKEN ARE TO BE PLANTED OR PROVIDED WITH PROTECTIVE CONVER WITHIN 15 WORKING OR 90 CALENDAR DAYS OF PROJECT COMPLETION.

6. AS CONSTRUCTION PROGRESSES, INSTALL PERMANENT EROSION CONTROL MEASURES AS SUCH AS RIP RAP APRONS, CHECK DAMS, CHANNEL LINERS, GRAVEL BASE CONTROL OFFICE.

7. INSTALL STORM DRAINAGE PIPE AND APPURTENCES AND PROTECT WITH TEMPORARY SILT PROTECTION.

8. PERFORM GRADING OPERATIONS TO MINIMIZE DISTURBED AREAS.
9. MAINTAIN ALL SEDIMENT CONTROL DEVICES IN PROPER WORKING

ORDER AND CLEAN TRAPS AND BASINS WHEN HALF FULL.

10. WHEN CONSTRUCTION IS COMPLETE, FRAME & GRATE IS

TO REMAIN IN PLACE. POND IS TO BE GRADED TO FINAL DESIGN

CONFIGURATION TO FUNCTION AS A BIORETENTION POND.

11. CONSTRUCT FILL SLOPES AND RETAINING WALLS. ALL CONSTUCTED SLOPES 2'H:1'V AND STEEPER REQUIRE GEOGRID STABILIZATION. INSTALL STORM SEWER PIPES AS FILL REACHES ALONG THE LINE OF PIPE INVERT.

12. MAINTAIN SOIL EROSION CONTROL MEASURES UNTIL PERMANENT

GROUND COVER IS ESTABLISHED.

13. WHEN CONSTRUCTION IS COMPLETE AND ALL AREAS ARE STABILIZED, CALL FOR ON SITE INSPECTION BY THE SEDIMENTATION AND EROSION CONTROL OFFICE.

14. IF SITE IS APPROVED, REMOVE TEMPORARY DIVERSIONS, SILT FENCE, ETC., AND SEED, PAVE, OR RIP RAP RESULTING DISTURBED AREAS.

15. WHEN VEGETATION HAS BECOME ESTABLISHED, CALL FOR A FINAL SITE INSPECTION, IF THE SITE IS APPROVED, THE PERFORMANCE BOND, IF REQUIRED, WILL BE RELEASED.



NELSON ROAD CARY, NORTH CAROLINA



COMPLETE FACILITIES SOLUTIONS

MOSER

MAYER

328 E. Market Street
Suite 200

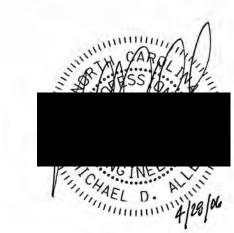
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